


ARA No. _____

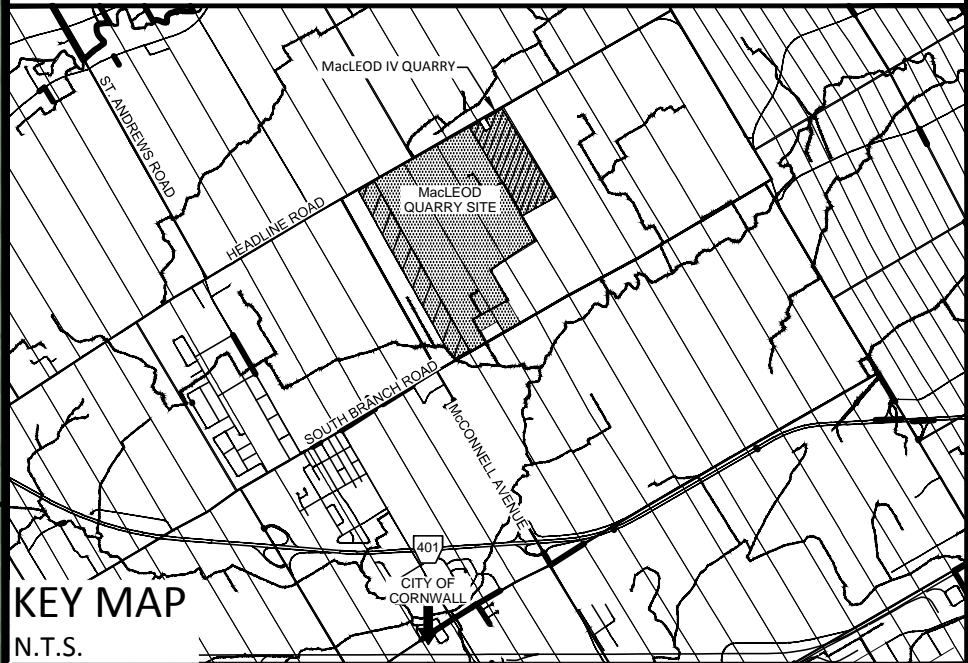

LOCATION OF SITE
PART OF LOT 2
CONCESSION 4
GEOGRAPHIC TOWNSHIP OF CORNWALL
COUNTY OF SOUTH STORMONT

APPLICANT & PROPERTY OWNER
CORNWALL GRAVEL COMPANY
P.O. BOX 67 - 390 ELEVENTH STREET WEST
CORNWALL, ONTARIO, K6H 5R9

DATE _____ PETER GRANT, VICE PRESIDENT
I HAVE THE AUTHORITY
TO BIND THE CORPORATION

PLAN CERTIFICATION
I HEREBY CERTIFY THAT THIS SITE PLAN WAS PRODUCED
UNDER MY SUPERVISION.

DATE _____ MARK PRIDDLE, P.GEO.

SCALE 1 : 2000
0 50 100 150 200 Metres
DISTANCES SHOWN ARE IN METRES AND CAN BE CONVERTED TO FEET
BY DIVIDING BY 0.3048. ALL ELEVATIONS ON THIS PLAN ARE GEODETIC.

AREAS	DESCRIPTION	AREA(ha)
	PROPERTY	40.5
	LICENCE AREA	40.5
	EXTRACTION AREA	32.4

SITE BENCHMARKS	No.	DESCRIPTION	NORTHING	EASTING	ELEVATION
	A	CONTROL 7 - SCALE HOUSE WELL	4992474.452	519456.395	74.613

No.	Amendment	Date

McINTOSH PERRY **MP**
115 Walgreen Road R.R. #3, Carp, ON K0A 1I0
Tel: 613-836-2184 Fax: 613-836-3742

Client:
CORNWALL GRAVEL COMPANY LIMITED

Project:
MACLEOD 5
CATEGORY 1 CLASS "A" PIT BELOW WATER
CATEGORY 2 CLASS "A" QUARRY BELOW WATER

Drawing Title:
EXISTING FEATURES PLAN

Drawn By:	DL	Project Number:	
Checked By:	MP		CP-16-0280
Paper Size:	Scale:	Drawing Number:	
24" x 36"	1:2000 (metric)	Sheet 1 of 8	
Date:	AUG. 17, 2017		



EXISTING FEATURES NOTES

1.1.1 DRAWINGS
THE DRAWING NUMBER AND TOTAL NUMBER OF DRAWINGS CAN BE FOUND IN THE BOTTOM RIGHT CORNER OF ALL DRAWINGS.

1.1.2 KEY MAP
A KEY MAP SHOWING THE LOCATION OF THE SITE IS LOCATED IN THE TOP RIGHT CORNER OF ALL DRAWINGS.

1.1.3 SITE PLANS
GENERAL DESCRIPTION OF THE SITE:
PART OF LOT 2
CONCESSION 4
GEOGRAPHIC TOWNSHIP OF CORNWALL
COUNTY OF SOUTH STORMONT

1.1.4 PLAN SCALE
THE SCALE OF THE PLAN VIEW IS 1:2000 (METRIC). A GRAPHICAL REPRESENTATION OF THE SCALE IS SHOWN ON THE RIGHT SIDE OF ALL DRAWINGS

1.1.5 APPLICANT
THE APPLICANT'S NAME AND ADDRESS IS:
CORNWALL GRAVEL COMPANY LIMITED
390 ELEVENTH STREET WEST
CORNWALL, ONTARIO, K6H 5R9

1.1.6 STATEMENT
THIS SITE PLAN IS PREPARED UNDER THE AGGREGATE RESOURCES ACT FOR A CLASS A LICENCE, CATEGORY 1 PIT BELOW WATER AND, CATEGORY 2 QUARRY BELOW WATER UNDER THE AGGREGATE RESOURCES OF ONTARIO PROVINCIAL STANDARDS, VERSION 1.0.

1.1.7 STAMP
ALL OF THE DRAWINGS HAVE BEEN SIGNED AND SEALED BY MR MARK PRIDDLE, P.GEO. (APPROVED UNDER SUBSECTION 8(4) OF THE AGGREGATE RESOURCES ACT) WHO DESIGNED AND REVIEWED THE PLANS BASED ON THE TECHNICAL STUDIES PREPARED IN SUPPORT OF THIS QUARRY AND BASED ON THE PROVINCIAL STANDARDS OF THE AGGREGATE RESOURCES ACT OF ONTARIO. IN ADDITION, ALL OF THE DRAWINGS HAVE BEEN SIGNED UP BY THE APPLICANT, DAVID GRANT, PRESIDENT OF CORNWALL GRAVEL COMPANY LIMITED.

1.1.8 NORTH ARROW
THE NORTH ARROW IS LOCATED IN THE TOP RIGHT CORNER OF ALL DRAWINGS.

1.1.9 AMENDMENTS
A SECTION FOR RECORDING SITE PLAN AMENDMENTS, INCLUDING APPROVAL DATES, HAS BEEN PROVIDED AND CAN BE FOUND ON THE RIGHT SIDE OF ALL DRAWINGS.

1.1.10 LIST OF PLANS USED
THIS SITE PLAN WAS PREPARED USING THE FOLLOWING RESOURCES:
1. LEGAL OF THE SITE CONDUCTED BY MCINTOSH PERRY SURVEYING INC.
2. REFERENCE PLANS 52R-5986
3. LIDAR IMAGING PROVIDED BY RME GEOMATICS, AUGUST 2016.

1.1.11 LEGEND
THE LEGEND IS LOCATED ON THE RIGHT SIDE OF ALL DRAWINGS.

1.1.12 BOUNDARY
THE AREA TO BE LICENSED IS ±40.50 HECTARES, DIMENSIONED AS SHOWN ON THE PLAN.

1.1.13 CADASTRAL
DEMARICATION OF THE LOT AND CONCESSION LINES ARE SHOWN ON THE PLAN.

1.1.14 LAND USE AND EXISTING ZONING
EXISTING ZONING OF THE SUBJECT PROPERTY AND ADJACENT PROPERTIES WITHIN 120M IS SHOWN ON THE PLAN, AND IS BASED ON THE TOWNSHIP OF SOUTH STORMONT ZONING BY-LAW NO. 2011-100, AS AMENDED BY 2015-050.

1.1.15 TOPOGRAPHY
THE TOPOGRAPHY OF THE SITE IS ILLUSTRATED ON THE PLAN AT 2M CONTOUR INTERVALS, EXPRESSED AS METRES ABOVE MEAN SEA LEVEL (ASL).

1.1.16 LOCATION AND USE OF BUILDINGS AND STRUCTURES ONSITE AND WITHIN 120 M OF THE SITE
ALL EXISTING BUILDINGS LOCATED ON OR WITHIN 120M OF THE SITE ARE SHOWN ON THE PLAN. THERE ARE NO EXISTING BUILDINGS ON SITE.

1.1.17 LOCATION OF EXISTING ENTRANCES AND EXITS FROM THE SITE
THE SITE DOES NOT CURRENTLY HAVE DIRECT ACCESS TO MUNICIPAL ROADS. THERE IS AN EMERGENCY ENTRANCE/EXIT LOCATED ON THE NORTH WEST CORNER OF THE PROPERTY. ALL ENTRANCES AND EXITS EXISTING ON THE SITE ARE CURRENTLY CLOSED TO THE PUBLIC.

1.1.18 INTERNAL HAUL ROADS
EXISTING HAUL ROADS ARE SHOWN ON THIS PLAN.

1.1.19 ELEVATION OF THE WATER TABLE
THE GROUNDWATER TABLE HAS BEEN ESTABLISHED ON-SITE. ACCORDING TO THE HYDROGEOLOGICAL REPORT ON-SITE, THE AVERAGE LONG-TERM GROUNDWATER ELEVATION IS ESTIMATED AT APPROXIMATELY 58m ASL.

1.1.20 EXISTING SURFACE WATER AND DRAINAGE FACILITIES
ALL EXISTING SURFACE WATER DRAINAGE FACILITIES AND DIRECTIONS ARE SHOWN ON THE PLAN.

1.1.21 LOCATION/TYPE OF EXISTING FENCING
ALL EXISTING FENCES ARE SHOWN ON THE PLAN. TYPES OF FENCING INCLUDE POST AND WIRE.

1.1.22 EXISTING TREE COVER
EXISTING TREE COVER IS SHOWN ON THE PLAN.

1.1.23 EXISTING STOCKPILES OF TOPSOIL AND OVERBURDEN
THERE ARE NO EXISTING STOCKPILES OF TOPSOIL OR OVERBURDEN ON SITE.

1.1.24 EXISTING AGGREGATE STOCKPILES/RECYCLABLE MATERIAL
THERE ARE NO EXISTING STOCKPILES OF AGGREGATE OR RECYCLABLE MATERIALS ON SITE.

1.1.25 EXISTING SCRAP LOCATIONS
THERE IS NO EXISTING SCRAP STORAGE ON SITE.

1.1.26 EXISTING FUEL STORAGE AREA
THERE IS NO EXISTING FUEL STORAGE ON SITE.

1.1.27 SIGNIFICANT NATURAL FEATURES ON AND WITHIN 120 M OF THE SITE
UNEVALUATED WOODLAND EXISTS TO THE EAST OF THE MACLEOD V SITE.

1.1.28 SIGNIFICANT MAN-MADE FEATURES ON AND WITHIN 120 M OF THE SITE
MAN-MADE FEATURES ON AND WITHIN 120M OF THE SITE INCLUDE: RESIDENTIAL DWELLINGS, SHEDS, ROADS, DITCHES, AND POWER/COMMUNICATION LINES. THE EXISTING MACLEOD QUARRY (ARA 5942) IS LOCATED WEST OF THE SITE. ALL SIGNIFICANT MAN-MADE FEATURES ON AND WITHIN 120M OF THE SITE ARE SHOWN ON THE PLAN.

1.1.29 EXCAVATION FACES AND REHABILITATED AREA
THIS IS A NEWLY PROPOSED DEVELOPMENT, AND THEREFORE THERE ARE NO EXISTING EXCAVATION FACES OR REHABILITATED AREAS ON SITE.




1.1.30 EXISTING PROCESSING AREAS
THERE IS NO EXISTING PROCESSING AREA ON SITE.

1.1.31 EXISTING BERMS
AN EXISTING ±3.0M HIGH NOISE BARRIER BERM HAS BEEN CONSTRUCTED ALONG THE NORTH AND EAST SIDES OF THE PROPERTY AS PART OF THE MACLEOD QUARRY OPERATIONS.


1.1.32 LOCATION OF CROSS-SECTIONS
CROSS-SECTIONS FOR EXISTING CONDITIONS ARE PROVIDED ON PAGE 2 OF THESE PLANS (CROSS-SECTIONS A-A' B-B' AND C-C')

LEGEND	
	EXISTING GROUND SURFACE CONTOUR (m asl)
	EXISTING BUILDING
	EXISTING SITE ENTRANCE / EXIT
	PROPERTY LINE
	LICENCE BOUNDARY
	EXTRACTION BOUNDARY
	120m LICENCE OFFSET
	EXISTING ZONING BOUNDARY
	MUNICIPAL ROAD (ASPHALT)
	EXISTING GRAVEL
	EXISTING DITCH LINE
	EXISTING TREE LINE
	EXISTING FENCE LINE
	APPROXIMATE TEST WELL LOCATION
	EXISTING OFFSITE LEGAL
	EXISTING SURFACE DRAINAGE DIRECTION
	EXISTING WETLAND
	NEW BERM/ACOUSTIC BARRIER (OVERBURDEN STORAGE)

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ARA No. _____

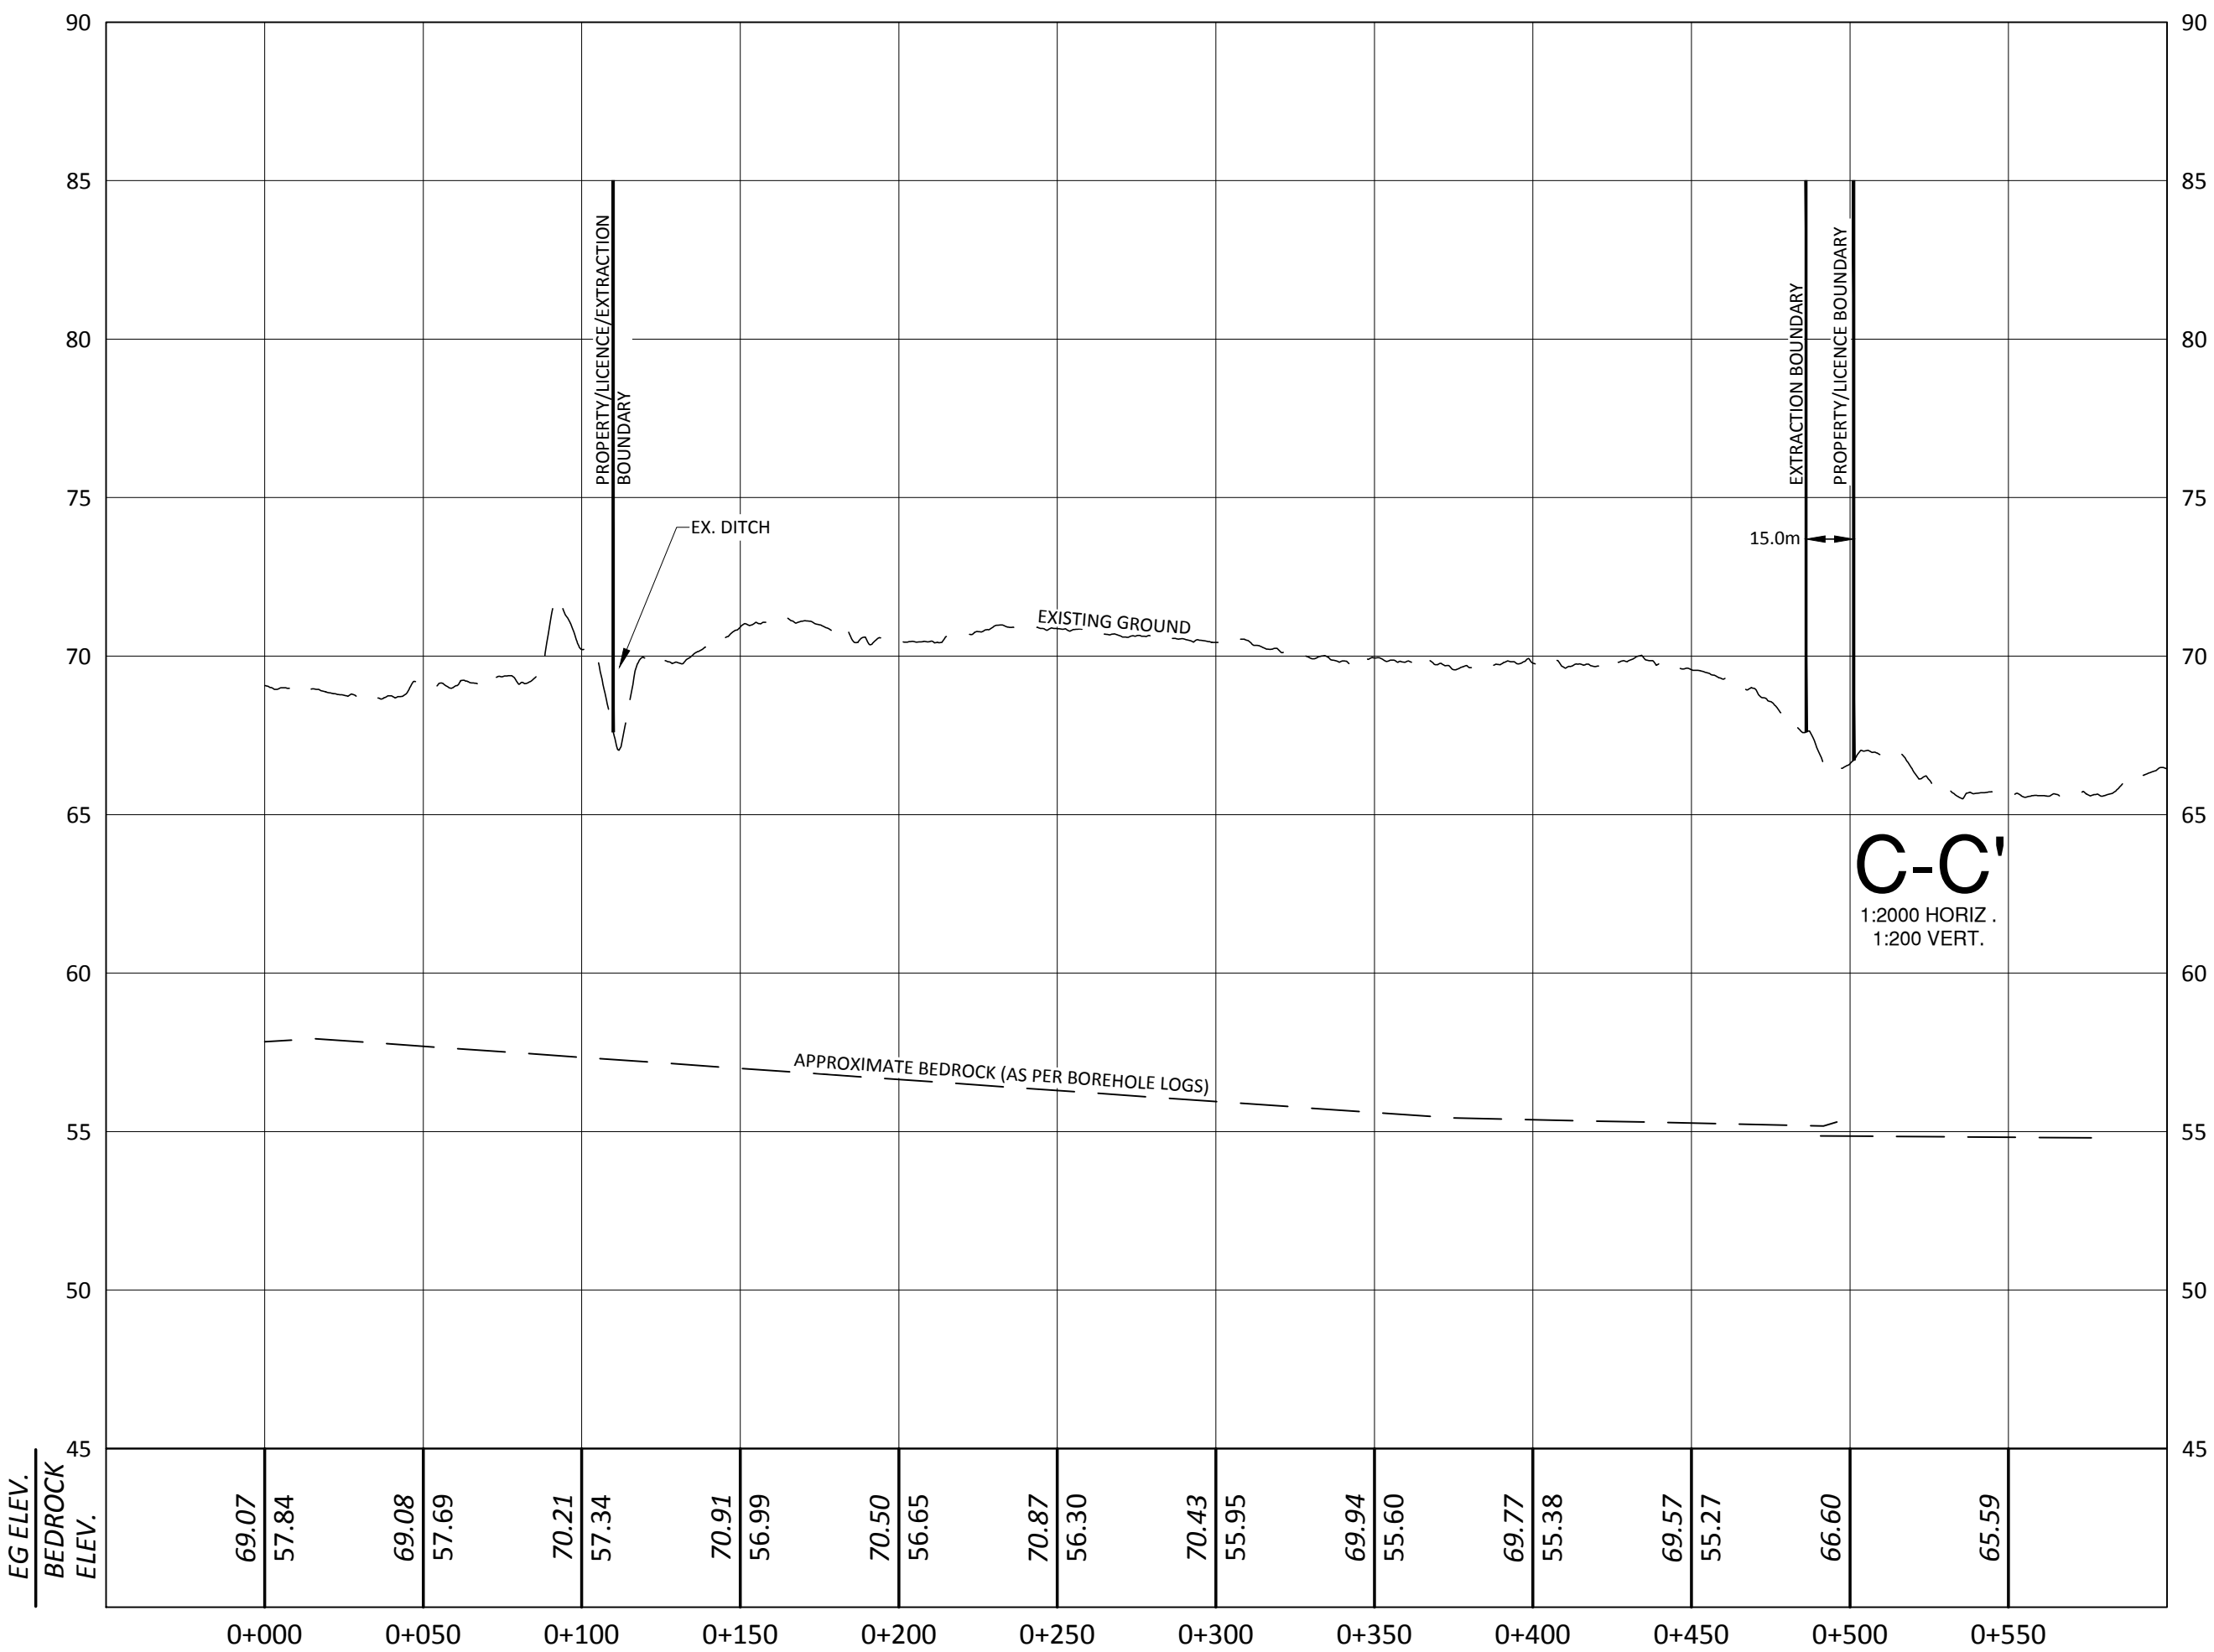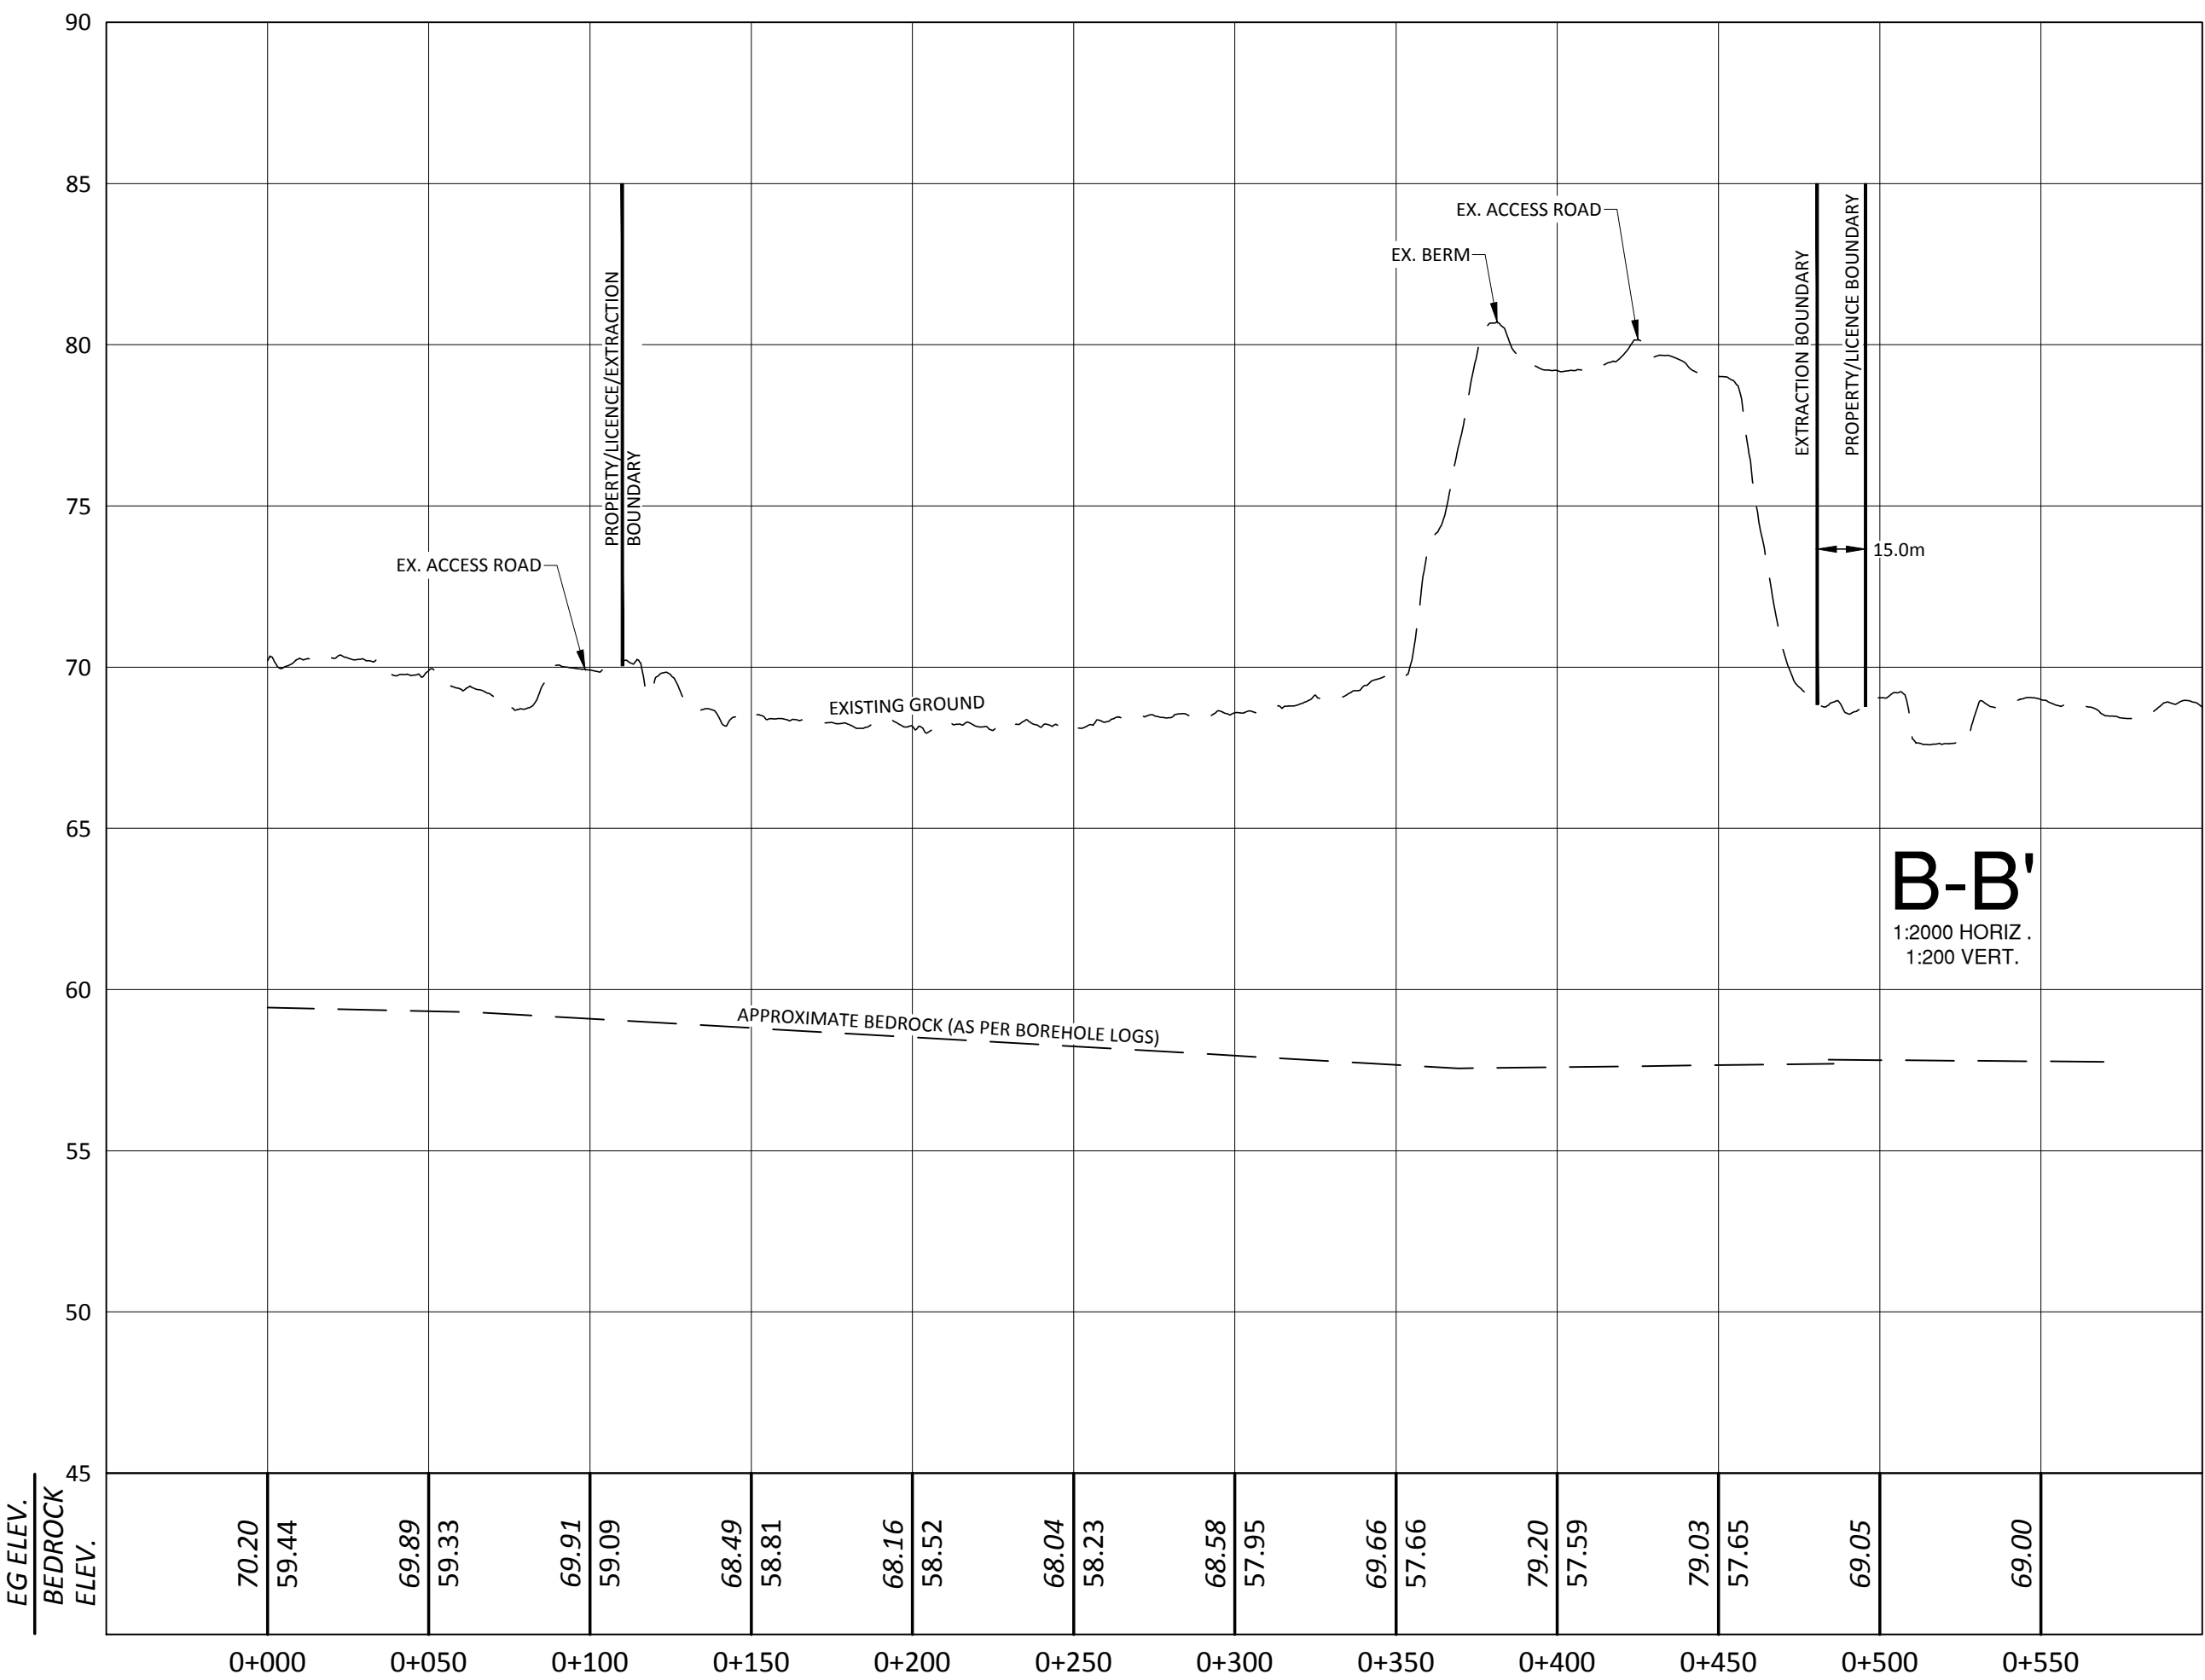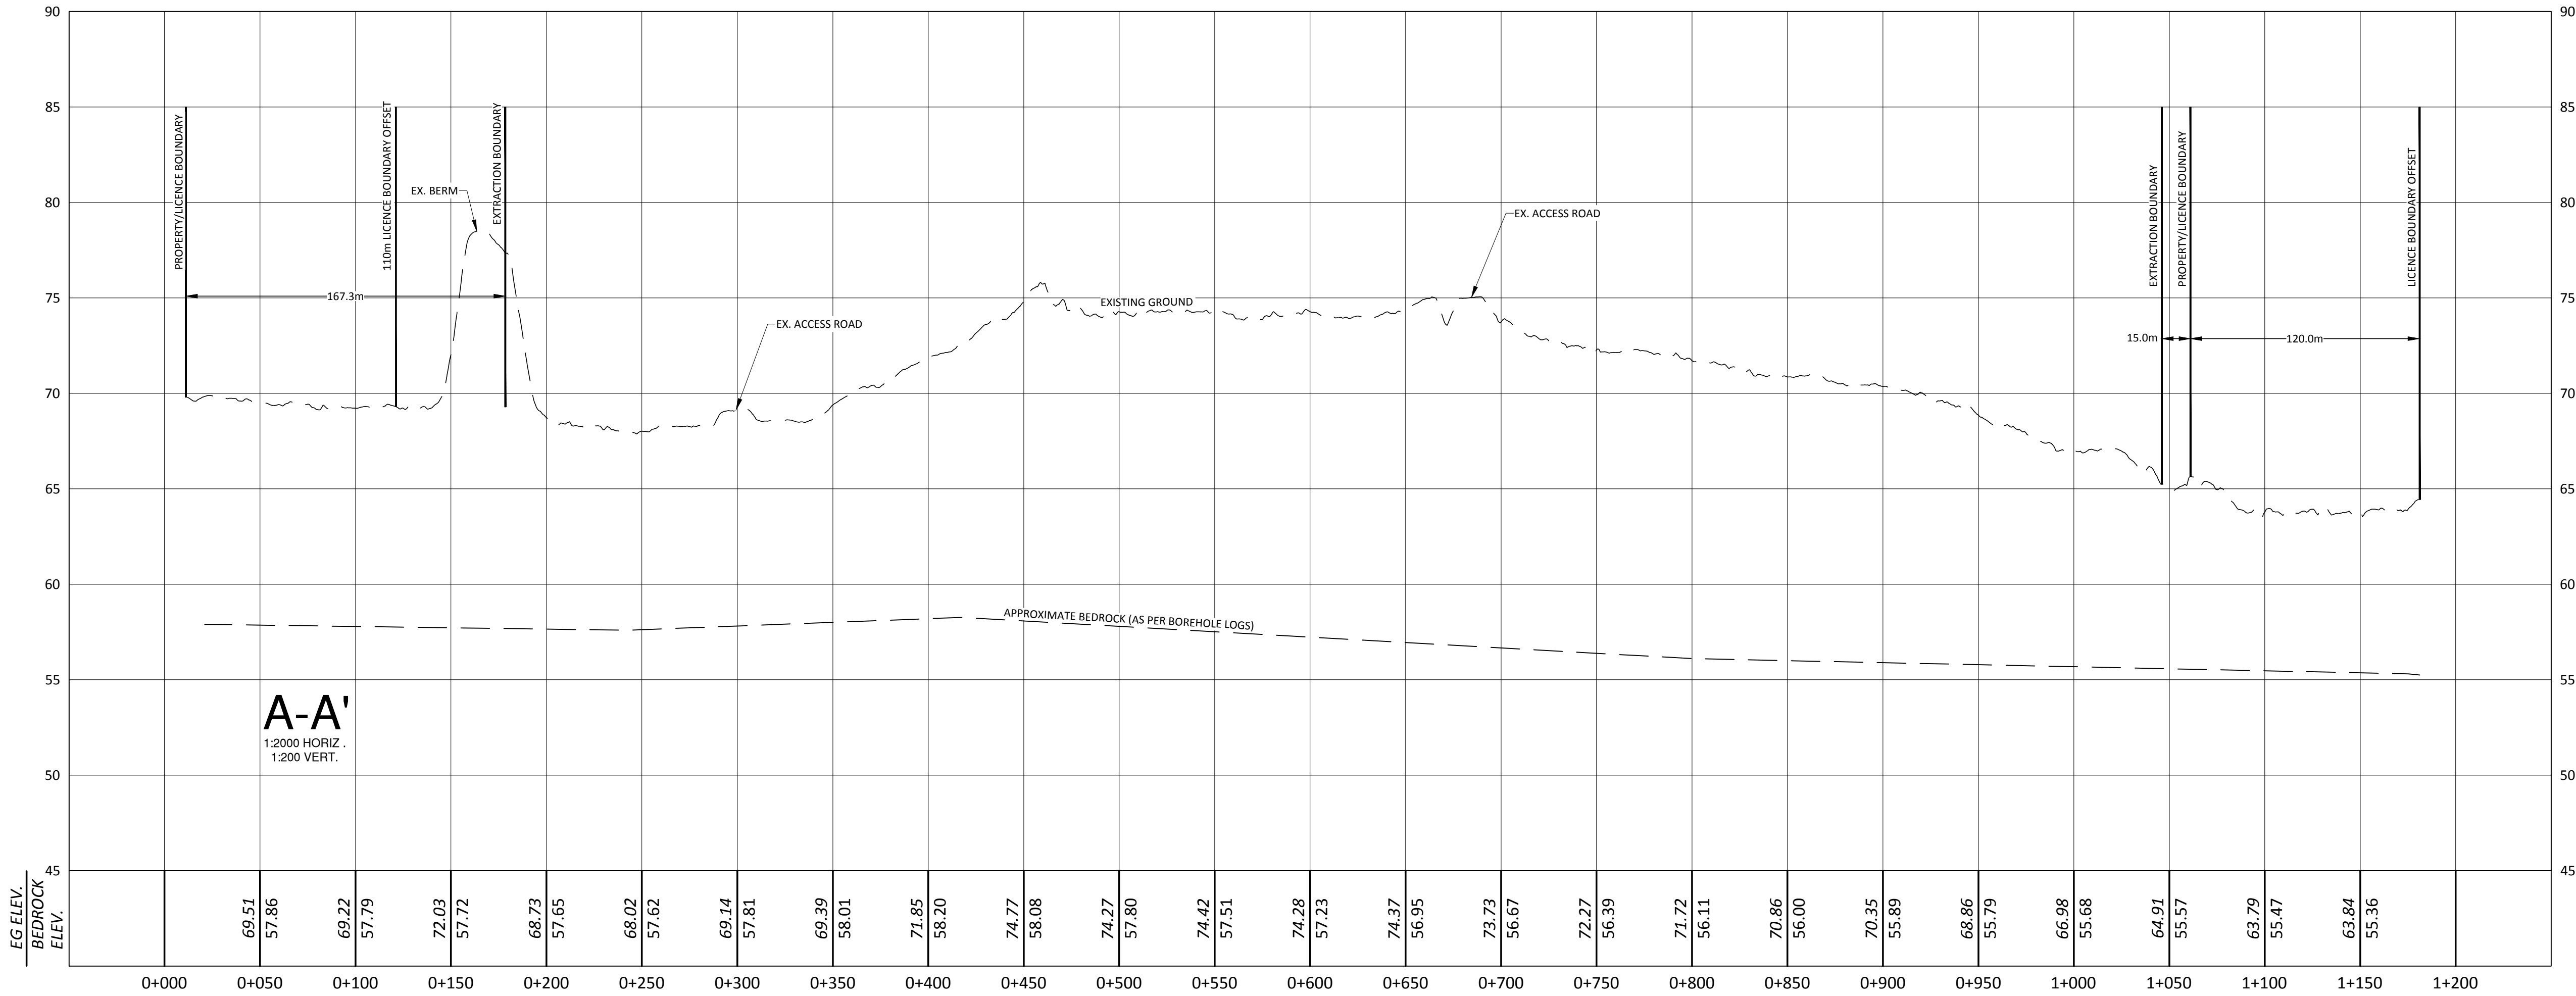

LOCATION OF SITE
PART OF LOT 2
CONCESSION 4
GEOGRAPHIC TOWNSHIP OF CORNWALL
COUNTY OF SOUTH STORMONT

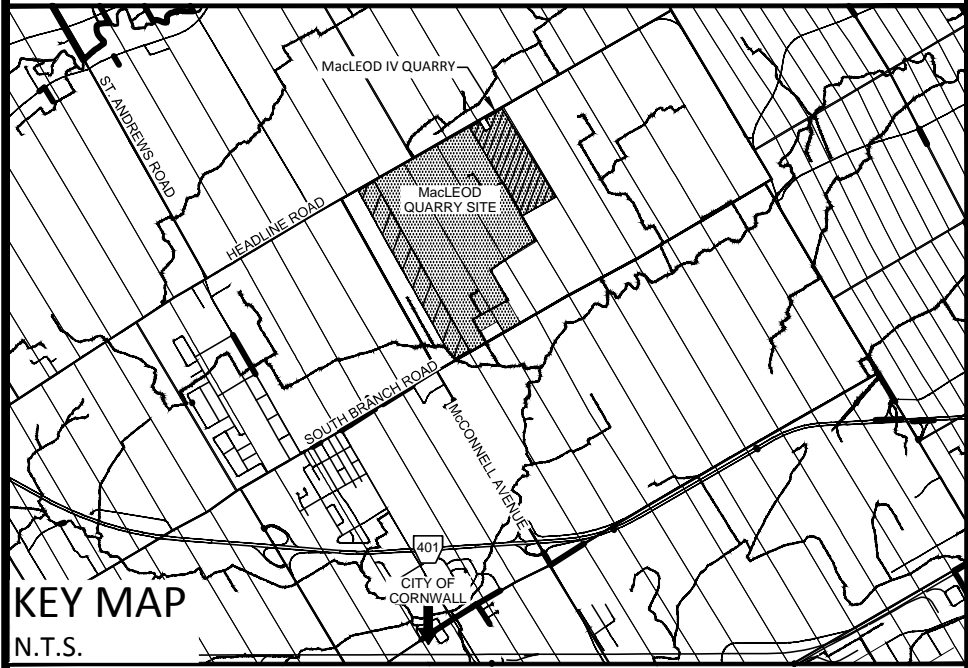APPLICANT & PROPERTY OWNER
CORNWALL GRAVEL COMPANY
P.O. BOX 67 - 390 ELEVENTH STREET WEST
CORNWALL, ONTARIO, K6H 5R9

DATE _____ PETER GRANT, VICE PRESIDENT
I HAVE THE AUTHORITY
TO BIND THE CORPORATION

PLAN CERTIFICATION
I HEREBY CERTIFY THAT THIS SITE PLAN WAS PRODUCED
UNDER MY SUPERVISION.

DATE _____ MARK PRIDDLE, P.GEO.

SCALE 1 : 2000
0 50 100 150 200 Metres
DISTANCES SHOWN ARE IN METRES AND CAN BE CONVERTED TO FEET
BY DIVIDING BY 0.3048. ALL ELEVATIONS ON THIS PLAN ARE GEODETIC.

DESCRIPTION	AREA(ha)
PROPERTY	40.5
LICENCE AREA	40.5
EXTRACTION AREA	32.4

No.	DESCRIPTION	NORTHING	EASTING	ELEVATION
A	CONTROL 7 - SCALE HOUSE WELL	4992474.452	519456.395	74.613

No.	Amendment	Date

McINTOSH PERRY **MP**
115 Walgreen Road R.R. #3, Carp, ON K0A 1L0
Tel: 613-836-2184 Fax: 613-836-3742

Client:
CORNWALL GRAVEL COMPANY LIMITED

Project:
MACLEOD 5
CATEGORY 1 CLASS "A" PIT BELOW WATER
CATEGORY 2 CLASS "A" QUARRY BELOW WATER

Drawing Title:
EXISTING FEATURES SECTIONS


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Date: AUG. 17, 2017	

APPLICANT & PROPERTY OWNER
CORNWALL GRAVEL COMPANY
P.O. BOX 67 - 390 ELEVENTH STREET WEST
CORNWALL, ONTARIO, K6H 5R9

PLAN CERTIFICATION

DATE _____ MARK PRIDDLE, P.GEO.

SCALE 1 : 2000



DISTANCES SHOWN ARE IN METRES AND CAN BE CONVERTED TO FEET BY DIVIDING BY 0.3048. ALL ELEVATIONS ON THIS PLAN ARE GEODETIC.

DESCRIPTION	AREA(ha)
PROPERTY	40.5
LICENCE AREA	40.5
EXTRACTION AREA	32.4

SITE BENCHMARKS

No.	DESCRIPTION	NORTHING	EASTING	ELEVATION
A	CONTROL 7 - SCALE HOUSE WELL	4992474.452	519456.395	74.613

No.	Amendment	Date
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FOR REVIEW ONLY
NOT FOR CONSTRUCTION



115 Walgreen Road R.R. #3, Carp, ON K0A 1L0
Tel: 613-836-2184 Fax: 613-836-3742

Client: **CORNWALL GRAVEL COMPANY LIMITED**


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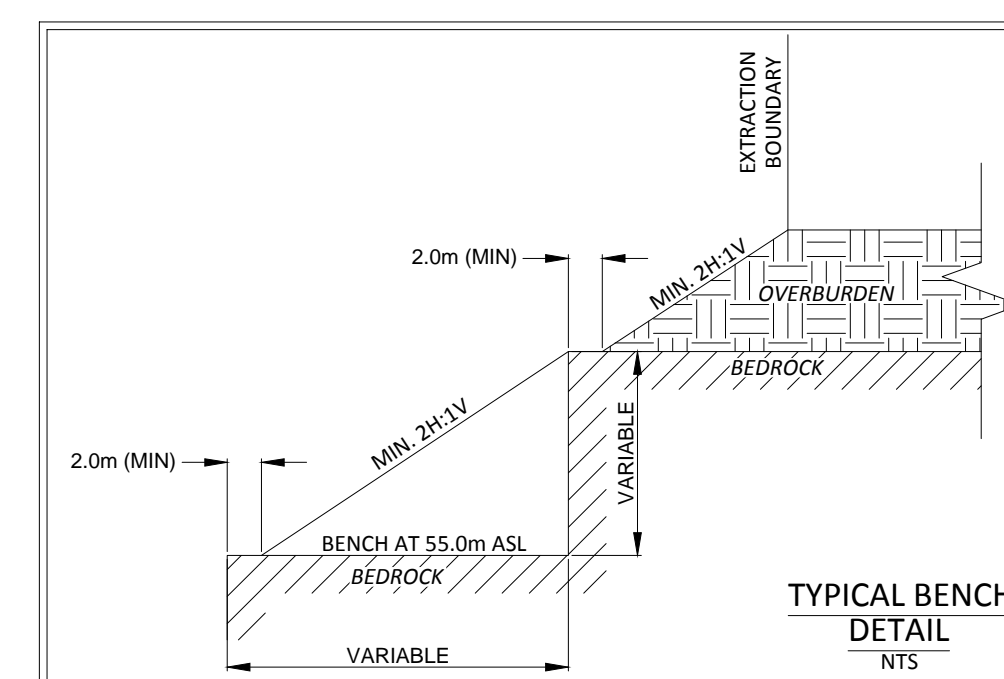
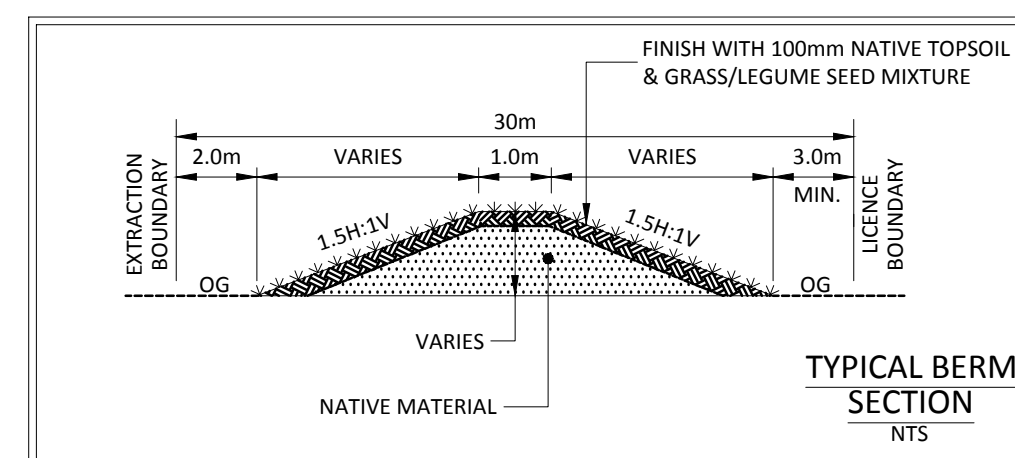
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Checked By: MP	CP-16-0280









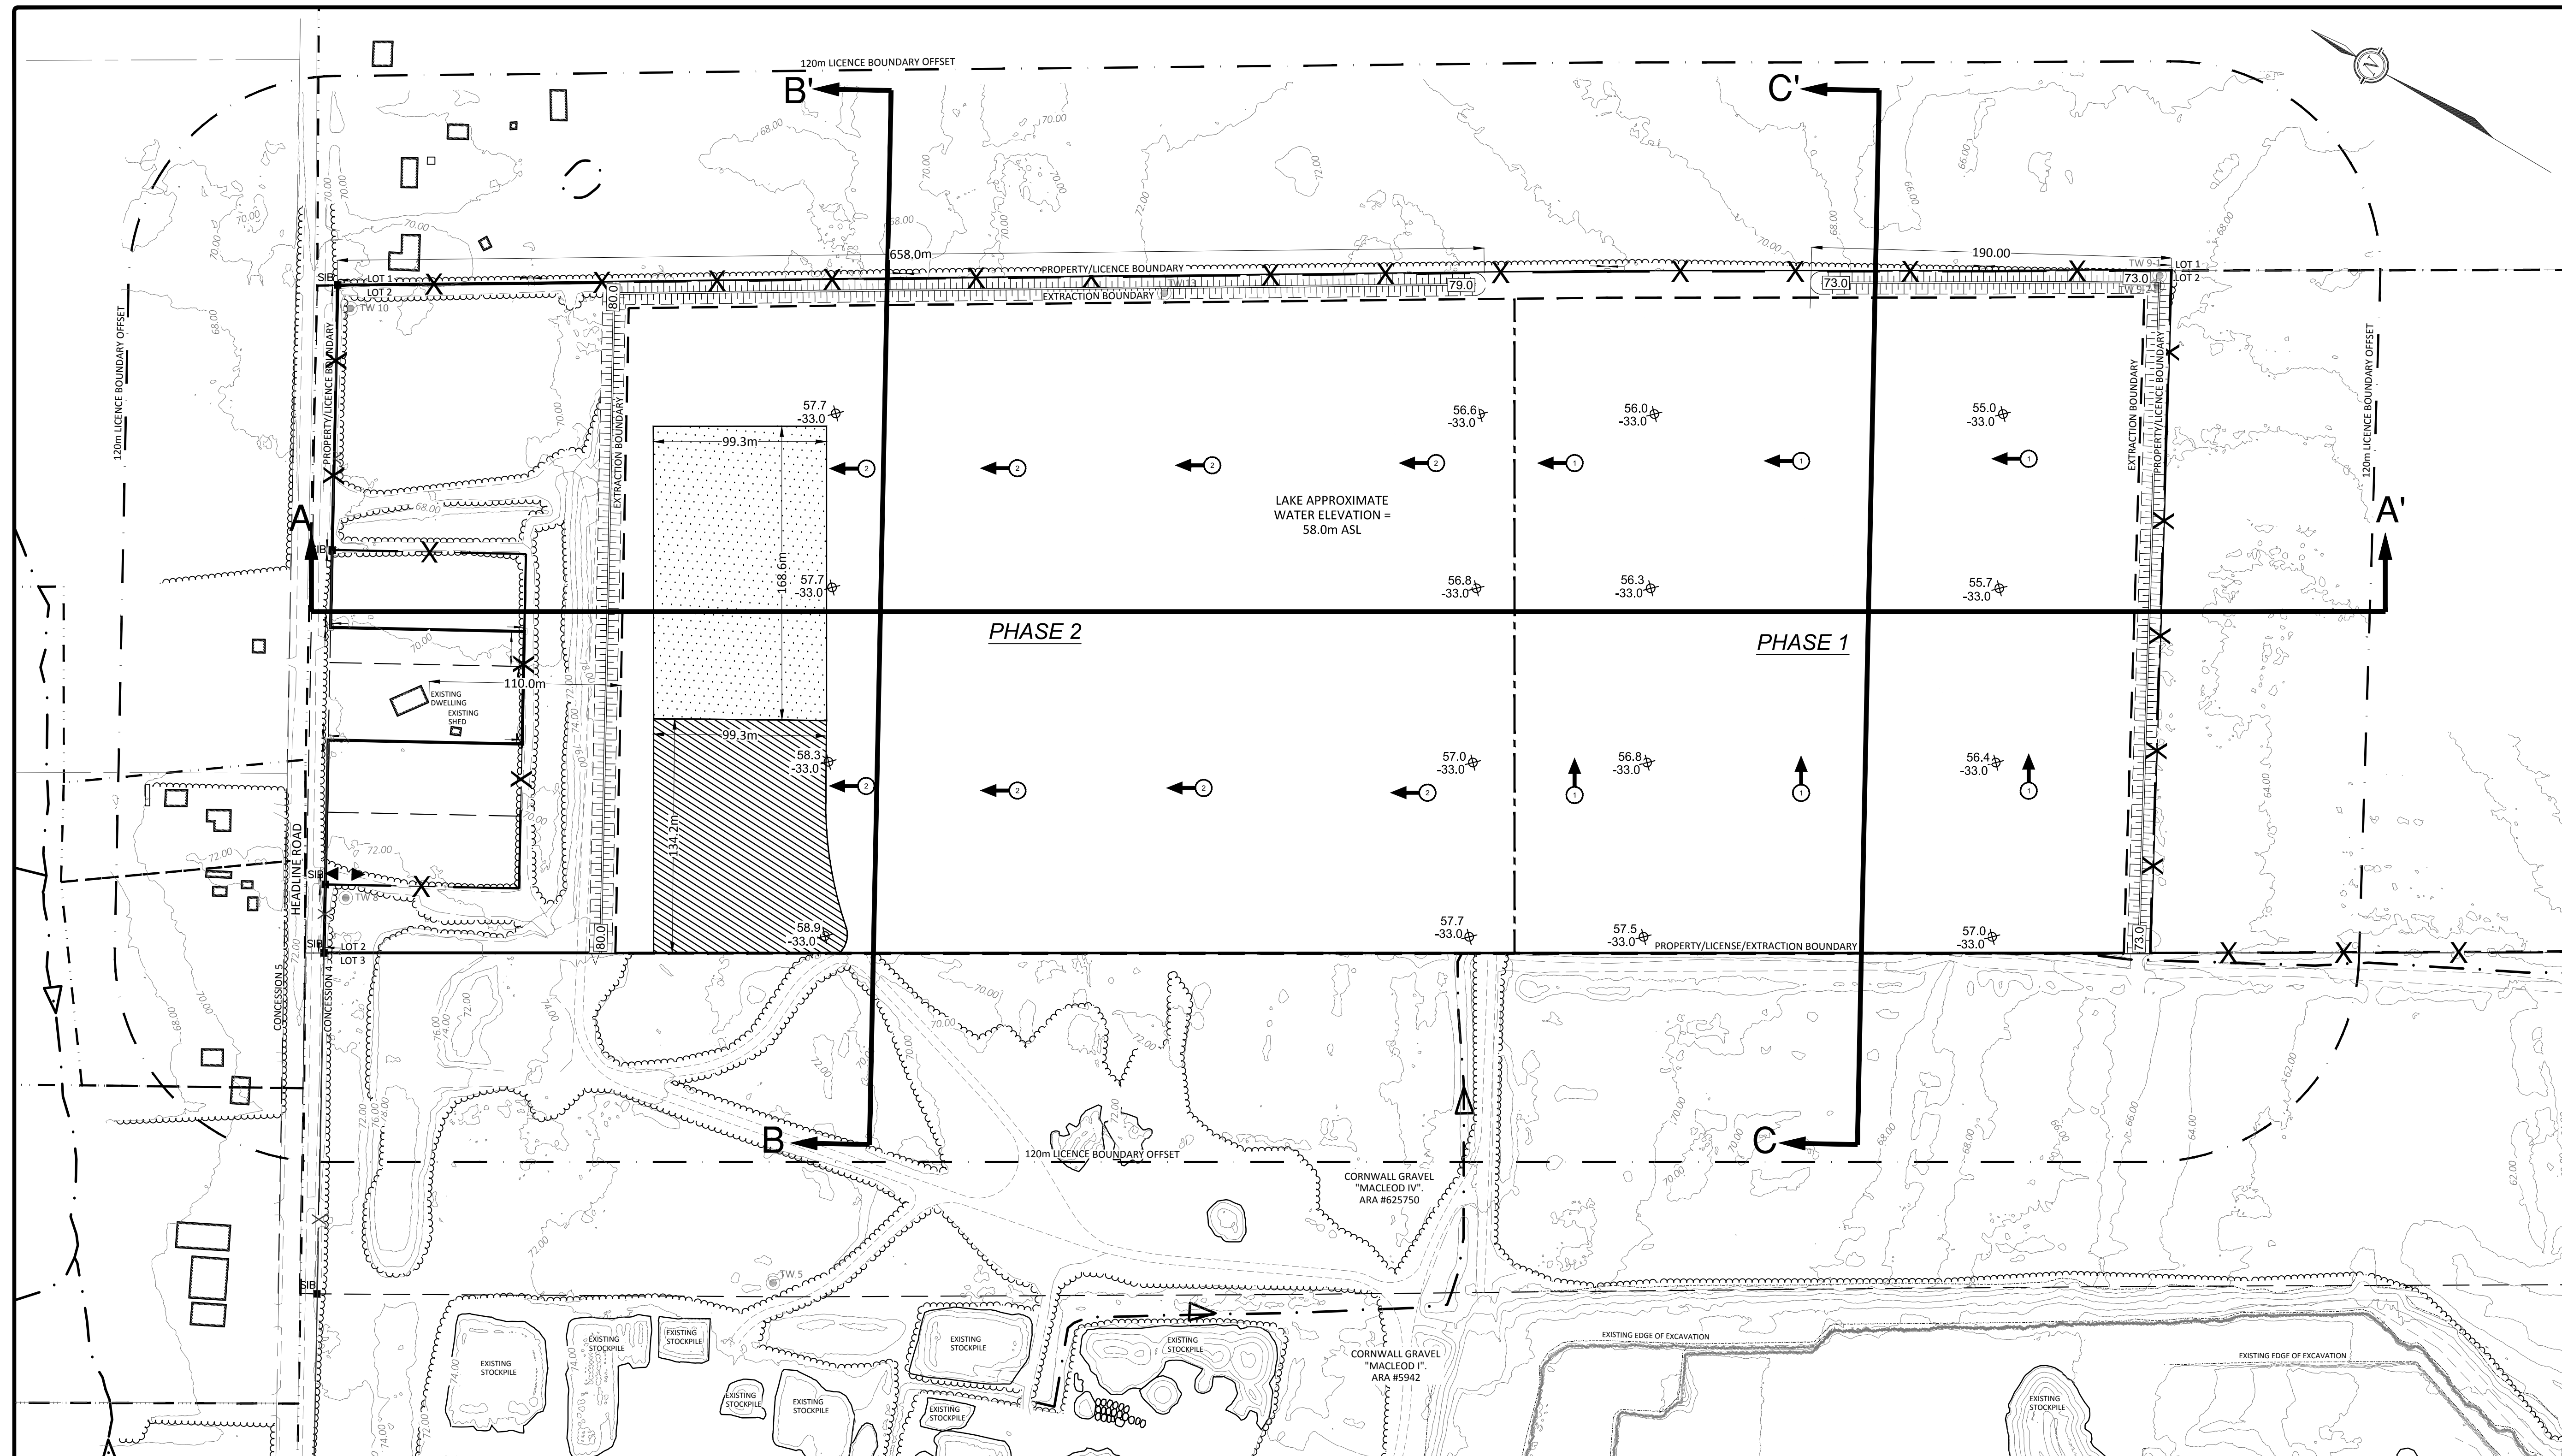
















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Date:	AUG. 17, 2017	Sheet 3 of 8	

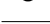

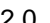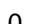NO.	VARIATIONS FROM OPERATIONAL STANDARDS	APPROVED BY INSPECTOR	DATE
	NO EXCAVATION SETBACK ALONG THE WEST BOUNDARY THAT ABUTS WITH CORNWALL GRAVEL PROPERTIES		
	A COMMON BOUNDARY AGREEMENT DOWN TO ELEV. -33.0m BETWEEN MACLEOD IV AND MACLEOD V ALONG WEST BOUNDARY		
	NO FENCING ALONG THE WEST BOUNDARY THAT ABUTS WITH CORNWALL GRAVEL PROPERTIES		
	EXCESS TOPSOIL MAY BE REMOVED FROM THE SITE		
	EXCESS OVERBURDEN MAY BE REMOVED FROM THE SITE		



LEGEND

- | | |
|---|---|
|  | EXISTING BUILDING |
|  | NEW SITE ENTRANCE / EXIT
(EQUIPPED WITH LOCKABLE GATE) |
|  | PROPERTY LINE |
|  | LICENCE BOUNDARY |
|  | EXTRACTION BOUNDARY |
|  | 120m LICENCE OFFSET |
|  | MUNICIPAL ROAD (ASPHALT) |
|  | EXISTING DITCH LINE |
|  | EXISTING BELL AND HYDRO POLE |
|  | EXISTING POLE ANCHOR |
|  | EXISTING FENCE LINE |
|  | APPROXIMATE TEST PIT LOCATION |
|  | APPROXIMATE TEST WELL LOCATION |
|  | EXISTING RESIDENTIAL WELL LOCATION |
|  | EXISTING OFF-SITE LEGAL |
|  | GENERAL DIRECTION OF PHASE EXTRACTION |
|  | ANTICIPATED PIT FLOOR ELEVATION (m ASL) |
|  | ANTICIPATED QUARRY FLOOR ELEVATION (m ASL) |
|  | PHASE LIMITS |
|  | MAIN INTERNAL HAUL ROAD |
|  | 1.2m HIGH POST AND WIRE FENCE |
|  | NEW BERM/ACOUSTIC BARRIER (OVERBURDEN STORAGE) |
|  | TOP OF BERM ELEVATION |
|  | DESIGNATED SCRAP LOCATION |
|  | DESIGNATED RECYCLED MATERIAL LOCATION |

FILENAME: A:\2016\Documents\2016\08\09 Cornwall Gravel - Add Application - Cornwall's Drawings\MacLeod V\05-16-02260 - MacLeod V - Rehabilitation.dwg
LAST SAVED: Thursday, August 17, 2017 LAST SAVED BY: d.bogumil
LAST PLOTTED: Thursday, August 17, 2017 CFB FILE USED: ---

1.2.1 SEQUENCE AND DIRECTION OF THE PROPOSED QUARRY DEVELOPMENT

THE OPERATION OF THIS QUARRY WILL OCCUR IN TWO (2) NUMBERED PHASES (PHASE 1 AND PHASE 2) AS THEY APPEAR ON THIS PLAN AND IN THE DIRECTION INDICATED BY ARROWS IN THE OPERATIONS PLAN.

PHASE ONE WILL CONSIST OF THE MIDDLE SECTION OF THE SITE AND WILL BE OPERATED IN A EASTERLY DIRECTION STARTING FROM THE SHARED BOUNDARY WITH THE MACLEOD IV QUARRY. PHASE 2 WILL CONSIST OF THE NORTH SECTION OF THE SITE AND WILL BE OPERATED IN A NORTHERLY DIRECTION STARTING AT THE PHASE BOUNDARY. MULTIPLE PHASES MAY BE OPERATED SIMULTANEOUSLY.

1.2.2 STRIPPING AND STOCKPILING OF TOPSOIL/OVERBURDEN

TOPSOIL AND OVERBURDEN MATERIAL WILL BE STRIPPED PROGRESSIVELY IN THE OPERATION OF THE SITE AND USED TO CONSTRUCT THE PERIMETER BERMS. TOPSOIL AND OVERBURDEN MATERIALS MAY ALSO BE TEMPORARILY STOCKPILED THROUGHOUT THE LICENSED AREA AS REQUIRED. TOPSOIL AND/OR OVERBURDEN STORED ONSITE WILL BE USED FOR BOTH PROGRESSIVE AND FINAL REHABILITATION OF THE SITE.

IT IS ANTICIPATED THAT APPROXIMATELY 4,700 CUBIC METRES OF TOPSOIL WILL BE REQUIRED TO REHABILITATE THE FINAL SIDE SLOPES TO A SLOPE OF 2(H):1(V) TO THE 55M CONTOUR. APPROXIMATELY 32,000 CUBIC METRES OF TOPSOIL IS CURRENTLY ONSITE.

IT IS ANTICIPATED THAT APPROXIMATELY 49,000 CUBIC METRES OF OVERBURDEN WILL BE REQUIRED TO REHABILITATE THE FINAL SIDE SLOPES TO A SLOPE OF 2(H):1(V) TO THE 55M CONTOUR. APPROXIMATELY 4,850,000 CUBIC METRES OF OVERBURDEN IS CURRENTLY ONSITE.

TOPSOIL AND OVERBURDEN IN EXCESS OF REHABILITATION REQUIREMENTS MAY BE EXPORTED AS NEEDED. THE REMOVAL OF EXCESS TOPSOIL/OVERBURDEN FROM SITE SHALL BE APPROVED BY THE MNRF UNDER A VARIATION FROM OPERATIONAL STANDARDS AS SHOWN AT THE BOTTOM OF THE OPERATIONS PAGE. SEE NOTE 1.2.25.

1.2.3 EXTRACTION LIFTS

BENCHES SHALL BE CONSTRUCTED AT 55.0M ASL, 30.0M ASL, 5.0M ASL, -20.0M ASL AND -33.0M ASL LOCATED AS SHOWN ON THE PLAN ABOVE. MULTIPLE LIFTS MAY OPERATE CONCURRENTLY. BENCH HEIGHT MAY VARY, HOWEVER EXTRACTION LIFTS AND BENCH HEIGHTS SHALL BE IN ACCORDANCE WITH ONTARIO MINISTRY OF LABOUR (MOL) REQUIREMENTS.

1.2.4 INTERNAL HAUL ROADS

THE LOCATION OF THE INTERNAL HAUL ROADS WILL VARY AS THE QUARRY IS DEVELOPED. GENERALLY AGGREGATE HAULAGE WILL BE DIRECTED TO MACLEOD I FOR PROCESSING. SOME SECONDARY AND TEMPORARY ROADS WILL BE CREATED AND REMOVED WITH THE EVOLUTION OF THE MACLEOD V QUARRY. DUST WILL BE MITIGATED ON SITE (SEE NOTE 1.2.17).

1.2.5 PROPOSED ENTRANCE AND EXIT

THE MAIN ACCESS TO THE QUARRY WILL BE FROM THE EXISTING MACLEOD I QUARRY. THE PROPOSED OPERATIONAL ENTRANCE/EXIT SHALL ENTER THE SITE AT THE WEST PROPERTY BOUNDARY FROM THE MACLEOD IV PROPERTY AND WILL NOT BE ACCESSIBLE TO THE PUBLIC. THE LOCATION OF THE ENTRANCE TO THE SITE WILL VARY AS THE QUARRY IS DEVELOPED. THERE IS ALSO AN EMERGENCY EXIT AT THE NORTH WEST CORNER OF THE MACLEOD V LICENSE BOUNDARY AS SHOWN ON THE OPERATIONS PLAN.

1.2.6 GROUNDWATER TABLE AND DEPTH OF EXTRACTION

THE GROUNDWATER TABLE HAS BEEN ESTABLISHED ON-SITE. ACCORDING TO THE HYDROGEOLOGICAL REPORT ON-SITE, THE AVERAGE LONG-TERM GROUNDWATER ELEVATION IS ESTIMATED AT APPROXIMATELY 58M ASL.

1.2.7 SURFACE WATER DIVERSION/DISCHARGE

NO WATER DIVERSION OR POINTS OF DISCHARGE TO SURFACE WATER ARE ANTICIPATED DURING PIT OPERATIONS. ANY WATER THAT ENTERS THE QUARRY MAY BE DISCHARGED FROM THE QUARRY AS NEEDED PROVIDED THAT ALL REQUIRED PROVINCIAL PERMITS IN PLACE.

1.2.8 PROPOSED FENCING

EXISTING FENCING ALONG THE PROPERTY BOUNDARIES SHALL REMAIN. IF EXISTING FENCING SURROUNDING THE SITE IS IN DISREPAIR, IT SHALL BE REBUILT WITH SIMILAR TYPE OR UPGRADED TO 1.2M POST AND WIRE FENCE AS REQUIRED. ALL FENCING SHALL BE INSTALLED / REBUILT PRIOR TO ANY EXTRACTION OPERATIONS. WHERE THE EXTRACTION BOUNDARY IS NOT CLEARLY DELINEATED BY FENCING, THE OPERATOR SHALL INSTALL STEEL POST MARKERS SPACED A MAXIMUM OF 30M APART ALONG THE EXTRACTION BOUNDARY PROVIDED THAT THEY DO NOT INTERFERE WITH FARMING OPERATIONS.

1.2.9 PROPOSED BUILDINGS AND STRUCTURES

NO BUILDING ARE PLANNED AT THIS TIME HOWEVER BUILDINGS MAY BE ADDED BY THE OPERATOR AS NEEDED PROVIDED THEY ARE PERMITTED BY THE ZONING BYLAW AND THE ENDANGERED SPECIES ACT. MOBILE SITE TRAILERS WILL BE ALLOWED FOR THE STORAGE OF EQUIPMENT.

1.2.10 LOCATION OF ANY PROPOSED STOCKPILES OF TOPSOIL/OVERBURDEN

NO TEMPORARY STOCKPILES OF TOPSOIL OR OVERBURDEN WILL BE LOCATED WITHIN 30 METRES FROM THE LICENSED BOUNDARY OF THE SITE. TOPSOIL AND OVERBURDEN NEEDED FOR REHABILITATION THAT IS STRIPPED DURING THE OPERATION OF THE SITE WILL BE STORED SEPARATELY IN BERMS AND/OR STOCKPILES. EXCESS TOPSOIL/OVERBURDEN MAY BE USED OFF SITE AS REQUIRED BY THE OPERATOR (I.E. SOLD AS FILL). ADEQUATE VEGETATION WILL BE ESTABLISHED TO CONTROL EROSION OF ANY BERM OR STOCKPILE OF TOPSOIL OR OVERBURDEN. BERMS ARE TO BE BUILT WITHIN EXCAVATION SETBACKS AS SHOWN ON THE PLAN.

1.2.11 LOCATION OF ANY PROPOSED AGGREGATE STOCKPILE AREA(S), INCLUDING ANY RECYCLABLE MATERIALS ON THE SITE

IT IS ANTICIPATED THAT AGGREGATES FROM MACLEOD V WILL BE TAKEN FROM MUCK PILES AND TRANSPORTED FOR PROCESSING AT THE MACLEOD I STATIONARY CRUSHER. ALTERNATIVELY, A MOBILE CRUSHING/SCREENING OPERATION MAY BE IMPLEMENTED IN WHICH CASE STOCKPILES WILL REMAIN WITHIN THE FOOTPRINT OF MACLEOD V UNTIL THEY ARE READY FOR TRANSPORT DIRECTLY OFFSITE. THE LOCATION OF THESE STOCKPILES WILL BE DETERMINED BY THE PHASING OF OPERATIONS AT THE TIME OF THEIR CONSTRUCTION.

ALL AGGREGATE STOCKPILES WILL BE LOCATED A MINIMUM OF 30 M AWAY FROM THE LICENCE BOUNDARY EXCEPT WHERE THERE IS A COMMON BOUNDARY AGREEMENT. AS AN ACCESSORY USE, RECYCLABLE MATERIALS SUCH AS CONCRETE AND ASPHALT MAY BE IMPORTED ONTO SITE IN ORDER TO BE PROCESSED FOR REUSE. THESE MATERIALS SHALL BE STORED IN A DESIGNATED AREA AT THE NORTH END OF THE SITE WHICH WILL BE DEMARCATED. IN ADDITION SOIL MEETING MOECC LEGISLATION MAY BE IMPORTED ONTO THE SITE AND STORED IN THE RECYCLABLE STORAGE AREA SEPARATED FROM NATIVE MATERIAL FROM THE SITE. THE IMPORTED SOIL SHALL NOT BE USED FOR PROGRESSIVE OR FINAL REHABILITATION.

1.2.12 PROPOSED SCRAP LOCATIONS

THE SCRAP GENERATED BY THE QUARRY'S OPERATIONS SHALL BE STORED WITHIN THE DESIGNATED SCRAP LOCATION AS SHOWN ON THE PLAN AND WILL BE REMOVED AS NEEDED. SCREENING OF THE SCRAP WILL BE PROVIDED BY THE OPERATOR. SCRAP SHALL NOT BE LOCATED WITHIN 30M OF ANY BODY OF WATER OR WITHIN 30M OF THE BOUNDARY OF THE SITE.

1.2.13 PROPOSED FUEL STORAGE AREAS

FUEL MAY BE STORED ONSITE AS NEEDED PROVIDED IT IS IN COMPLIANCE WITH PROVINCIAL STANDARDS AND REGULATIONS. A SPILLS CONTINGENCY PROGRAM WILL BE DEVELOPED PRIOR TO SITE PREPARATION AND KEPT ON-SITE DURING OPERATIONS. FUEL STORAGE AREA SHALL NOT BE LOCATED WITHIN 30M OF ANY WATER BODY.

1.2.14 AREA TO BE EXTRACTION

THE AREA TO BE EXTRACTION IS 134.5 HECTARES.

1.2.15 LOCATION OF ALL EXCAVATION SETBACKS

THE LOCATION OF THE EXCAVATION SETBACKS ARE SHOWN AND LABELED ON THE PLAN. THERE WILL BE A 15 M SETBACK ON THE SOUTHERN AND EASTERN PROPERTY BOUNDARY AS SHOWN ON THE OPERATIONAL PLAN. ON THE NORTHERN BOUNDARY THERE WILL BE A 110 M SETBACK. THERE WILL BE NO SETBACK ON THE WESTERN PROPERTY BOUNDARY WITH MACLEOD IV. A COMMON BOUNDARY AGREEMENT WILL BE FORMED BETWEEN MACLEOD IV AND V OVER THE ENTIRE MINING DEPTH ALONG THE WESTERN BOUNDARY. THIS SHALL BE APPROVED BY THE MINISTRY OF NATURAL RESOURCES AND FORESTRY UNDER A VARIATION OF OPERATIONAL STANDARDS.

1.2.16 FINAL ELEVATION

THE FINAL ELEVATION OF THE QUARRY EXTRACTION SHALL BE -33.0M ASL OR HIGHER. FINAL QUARRY FLOOR ELEVATIONS ARE SHOWN ON THE PLAN AS SPOT ELEVATIONS.

1.2.17 PROPOSED PROCESSING AREAS

PRIMARY AGGREGATE CRUSHING OPERATIONS WILL TAKE PLACE AT MACLEOD 1. PORTABLE PROCESSING PLANTS (CRUSHING SCREENING, WASHING) MAY BE UTILIZED ON SITE AS REQUIRED BY THE OPERATOR.

THERE WILL BE NO PROCESSING WITHIN 30 METRES OF THE BOUNDARY OF THE SITE. DUST WILL BE MITIGATED ON SITE AND WILL BE IN COMPLIANCE WITH M.O.E.C.C. REQUIREMENTS. WATER OR ANOTHER PROVINCIAL APPROVED DUST SUPPRESSANT WILL BE APPLIED TO PROCESSING AREAS AS OFTEN AS REQUIRED TO MITIGATE DUST.

1.2.18 PROPOSED BERMS

BERMS SHALL BE CONSTRUCTED USING ON-SITE NATIVE OVERBURDEN MATERIAL, FINISHED WITH MINIMUM 100MM OF NATIVE TOPSOIL. BERMS TO BE CONSTRUCTED TO THE HEIGHTS AND IN THE LOCATIONS SHOWN ON THE PLAN.

AN EXISTING BERM IS LOCATED ALONG THE NORTH WEST EXTRACTION LIMIT AND SHALL BE MAINTAINED AT A MINIMUM HEIGHT OF 9.0M. THIS BERM IS A CONTINUATION OF THE EXISTING BERM FOLLOWING THE NORTH WESTERN EXTRACTION LIMIT OF MACLEOD IV. THIS BERM SHALL BE MAINTAINED AS NECESSARY DURING SITE PREPARATIONS SO AS TO PROVIDE ACUSTICAL SHIELDING FOR NEIGHBOURING RESIDENTS, AND SHALL REMAIN FOR THE PROJECT LIFETIME.

1.2.19 BERM VEGETATION AND MAINTENANCE

EARTH BERMS WILL BE VEGETATED WITH NATIVE VEGETATION AND SLOPES SHALL BE SEEDED TO ENSURE ADEQUATE VEGETATION IS ESTABLISHED AND MAINTAINED.

1.2.20 EQUIPMENT TO BE USED

THE EXTRACTION, PROCESSING AND SHIPMENT EQUIPMENT OPERATING IN THE PIT AND QUARRY MAY INCLUDE, BUT IS NOT LIMITED TO LOADERS, ROCK DRILLS, EXCAVATORS, BULDOZERS, BACKHOES, SCRAPERS, PORTABLE PROCESSING EQUIPMENTS INCLUDING CRUSHING, SCREENING WASHING AND CONVEYING EQUIPMENT. HAUL TRUCKS, WATER TRUCKS AND SERVICE TRUCKS FOR GENERAL OPERATIONS AND MAINTENANCE. DUST WILL BE MITIGATED ON SITE.

1.2.21 PROPOSED TREE SCREENS

NO NEW TREE SCREENS ARE PROPOSED FOR THE SITE. A 15 M WIDE NATURALIZED AREA WILL BE LEFT ALONG HEADLINE ROAD WHERE OPERATIONS PERMIT.

1.2.22 HOURS OF OPERATION

THE MACLEOD V QUARRY WILL OPERATE ON A 24 HOUR BASIS AND 7 DAYS PER WEEK. HOWEVER, LIMITATIONS ON EQUIPMENT USES IN RELATION TO THE TIME OF DAY ARE PROVIDED AS PART OF THE NOISE STUDY RECOMMENDATIONS. PLEASE REFER TO NOTE 1.2.28.

1.2.23 TREES AND STUMPS

CLEARING AND GRUBBING WILL BE UNDERTAKEN WHERE REQUIRED. ANY MERCHANTABLE WOOD WILL BE HARVESTED AND SOLD. STUMPS, BRANCHES AND OTHER WOODY MATERIAL MAY BE CHIPPED AND/OR STOCKPILED ON SITE (I.E. IN BERMS) OR SOLD AS MULCH. WOOD PRODUCTS WILL BE STORED OR DISPOSED OF IN ACCORDANCE WITH MINISTRY OF ENVIRONMENT REGULATIONS. WITHIN THE AREA TO BE EXTRACTION, ALL TREES WITHIN 5 METRES OF THE EXCAVATION FACE MUST BE REMOVED.

1.2.24 LOCATION OF CROSS-SECTIONS

THE LOCATION OF THE THREE (3) CROSS-SECTIONS ARE SHOWN ON THE PLAN.

1.2.25 VARIATIONS FROM OPERATIONAL STANDARDS

A SECTION TO RECORD SITE PLAN AMENDMENTS AND VARIATIONS FROM OPERATIONAL STANDARDS WITH APPROVAL DATES TO THIS SITE HAS BEEN INCLUDED ON EACH PLAN. VARIATIONS INCLUDED IN THE LICENSE APPLICATION INCLUDE:

- NO EXCAVATION SETBACK ON THE WEST BOUNDARY THAT ABUTS WITH CORNWALL GRAVEL PROPERTIES;
- A COMMON BOUNDARY AGREEMENT DOWN TO ELEV. -33.0m BETWEEN MACLEOD IV AND MACLEOD V ALONG WEST BOUNDARY;
- EXCESS TOPSOIL CAN BE REMOVED FROM SITE;
- EXCESS OVERBURDEN CAN BE REMOVED FROM SITE;
- NO FENCING ALONG THE WEST BOUNDARY THAT ABUTS WITH CORNWALL GRAVEL PROPERTIES

1.2.26 FREQUENCY AND TIMING OF BLASTS


THE FREQUENCY OF BLASTING WILL BE DICTATED BY THE OPERATORS NEEDS. BLASTING WILL BE PERFORMED IN ACCORDANCE WITH THE MOECC REGULATIONS AND GUIDELINES IN REGARDS TO NOISE AND VIBRATION. THE BLASTING CONTRACTOR WILL MONITOR THE NOISE AND VIBRATION (AIR AND GROUND) LEVELS AT ALL TIMES DURING BLASTING. PROPER RECORD KEEPING SHALL BE CONDUCTED AND MADE AVAILABLE FOR REVIEW BY MNRF UPON REQUEST. IN ACCORDANCE WITH OPERATIONAL STANDARDS, NO BLASTING WILL OCCUR AT THIS SITE ON A HOLIDAY OR BETWEEN 6 PM AND 8 AM ON THE FOLLOWING DAY. PLEASE REFER TO RECOMMENDATIONS PROVIDED AS PART OF THE BLASTING IMPACT ANALYSIS PREPARED IN SUPPORT OF THIS APPLICATION; NOTE 1.2.28.

1.2.27 MAXIMUM ANNUAL TONNAGE

THE MAXIMUM AMOUNT OF AGGREGATE TO BE REMOVED FROM THE SITE IN ANY CALENDAR YEAR IS NOT TO EXCEED 3,400,000 TONNES.

NO.	VARIATIONS FROM OPERATIONAL STANDARDS	APPROVED BY INSPECTOR	DATE
	NO EXCAVATION SETBACK ALONG THE WEST BOUNDARY THAT ABUTS WITH CORNWALL GRAVEL PROPERTIES		
	A COMMON BOUNDARY AGREEMENT DOWN TO ELEV. -33.0m BETWEEN MACLEOD IV AND MACLEOD V ALONG WEST BOUNDARY		
	NO FENCING ALONG THE WEST BOUNDARY THAT ABUTS WITH CORNWALL GRAVEL PROPERTIES		
	EXCESS TOPSOIL MAY BE REMOVED FROM THE SITE		
	EXCESS OVERBURDEN MAY BE REMOVED FROM THE SITE		

ARA No. _____

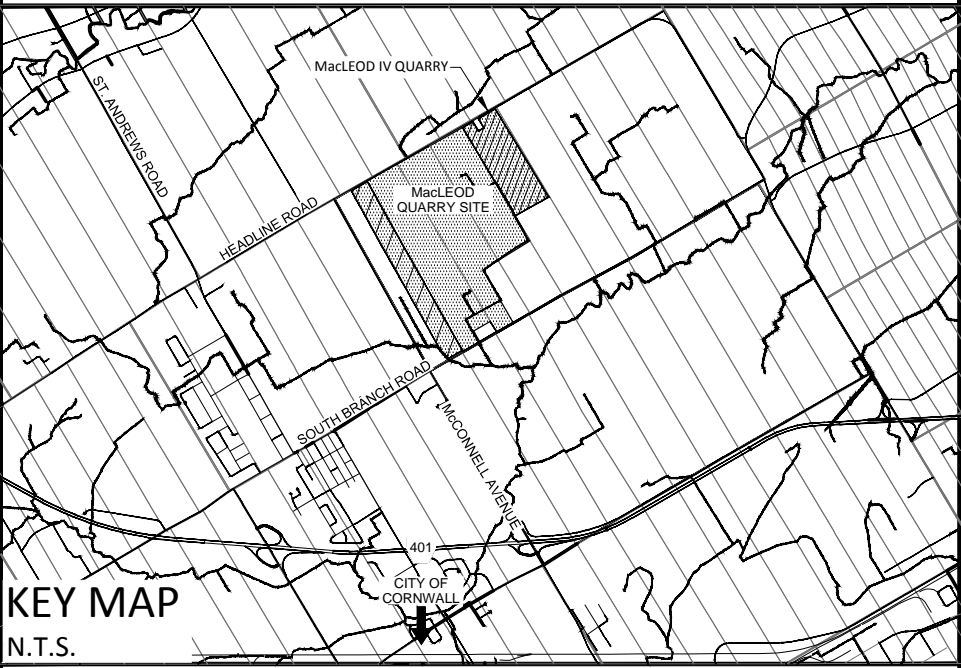

LOCATION OF SITE

PART OF LOT 2
CONCESSION 4
GEOGRAPHIC TOWNSHIP OF CORNWALL
COUNTY OF SOUTH STORMONT

APPLICANT & PROPERTY OWNER

CORNWALL GRAVEL COMPANY
P.O. BOX 67 - 390 ELEVENTH STREET WEST
CORNWALL, ONTARIO, K6H 5R9

DATE _____

PETER GRANT, VICE PRESIDENT

I HAVE THE AUTHORITY
TO BIND THE CORPORATION

PLAN CERTIFICATION

I HEREBY CERTIFY THAT THIS SITE PLAN WAS PRODUCED
UNDER MY SUPERVISION.

DATE _____

MARK PRIDDLE, P.GEO.

SCALE 1 : 2000



DISTANCES SHOWN ARE IN METRES AND CAN BE CONVERTED TO FEET
BY DIVIDING BY 0.3048. ALL ELEVATIONS ON THIS PLAN ARE GEODETIC.

AREAS

DESCRIPTION	AREA(ha)
PROPERTY	40.5
LICENCE AREA	40.5
EXTRACTION AREA	32.4

SITE BENCHMARKS

No.	DESCRIPTION	NORTHING	EASTING	ELEVATION
A	CONTROL 7 - SCALE HOUSE WELL	4992474.452	519456.395	74.613

No.	Amendment	Date



115 Walgreen Road R.R. #3, Carp, ON K0A 1L0
Tel: 613-836-2184 Fax: 613-836-3742

Client:

CORNWALL GRAVEL COMPANY LIMITED

Project:

MACLEOD 5
CATEGORY 1 CLASS "A" PIT BELOW WATER
CATEGORY 2 CLASS "A" QUARRY BELOW WATER

Drawing Title:

OPERATIONS SECTIONS (1)

Drawn By: DL

Checked By: MP

Paper Size: 24" x 36"

Scale: 1:2000 (metric)

Date: AUG. 17, 2017


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CP-16-0280

Drawing Number:

Sheet 4 of 8

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ARA No. _____

KEY MAP
N.T.S.

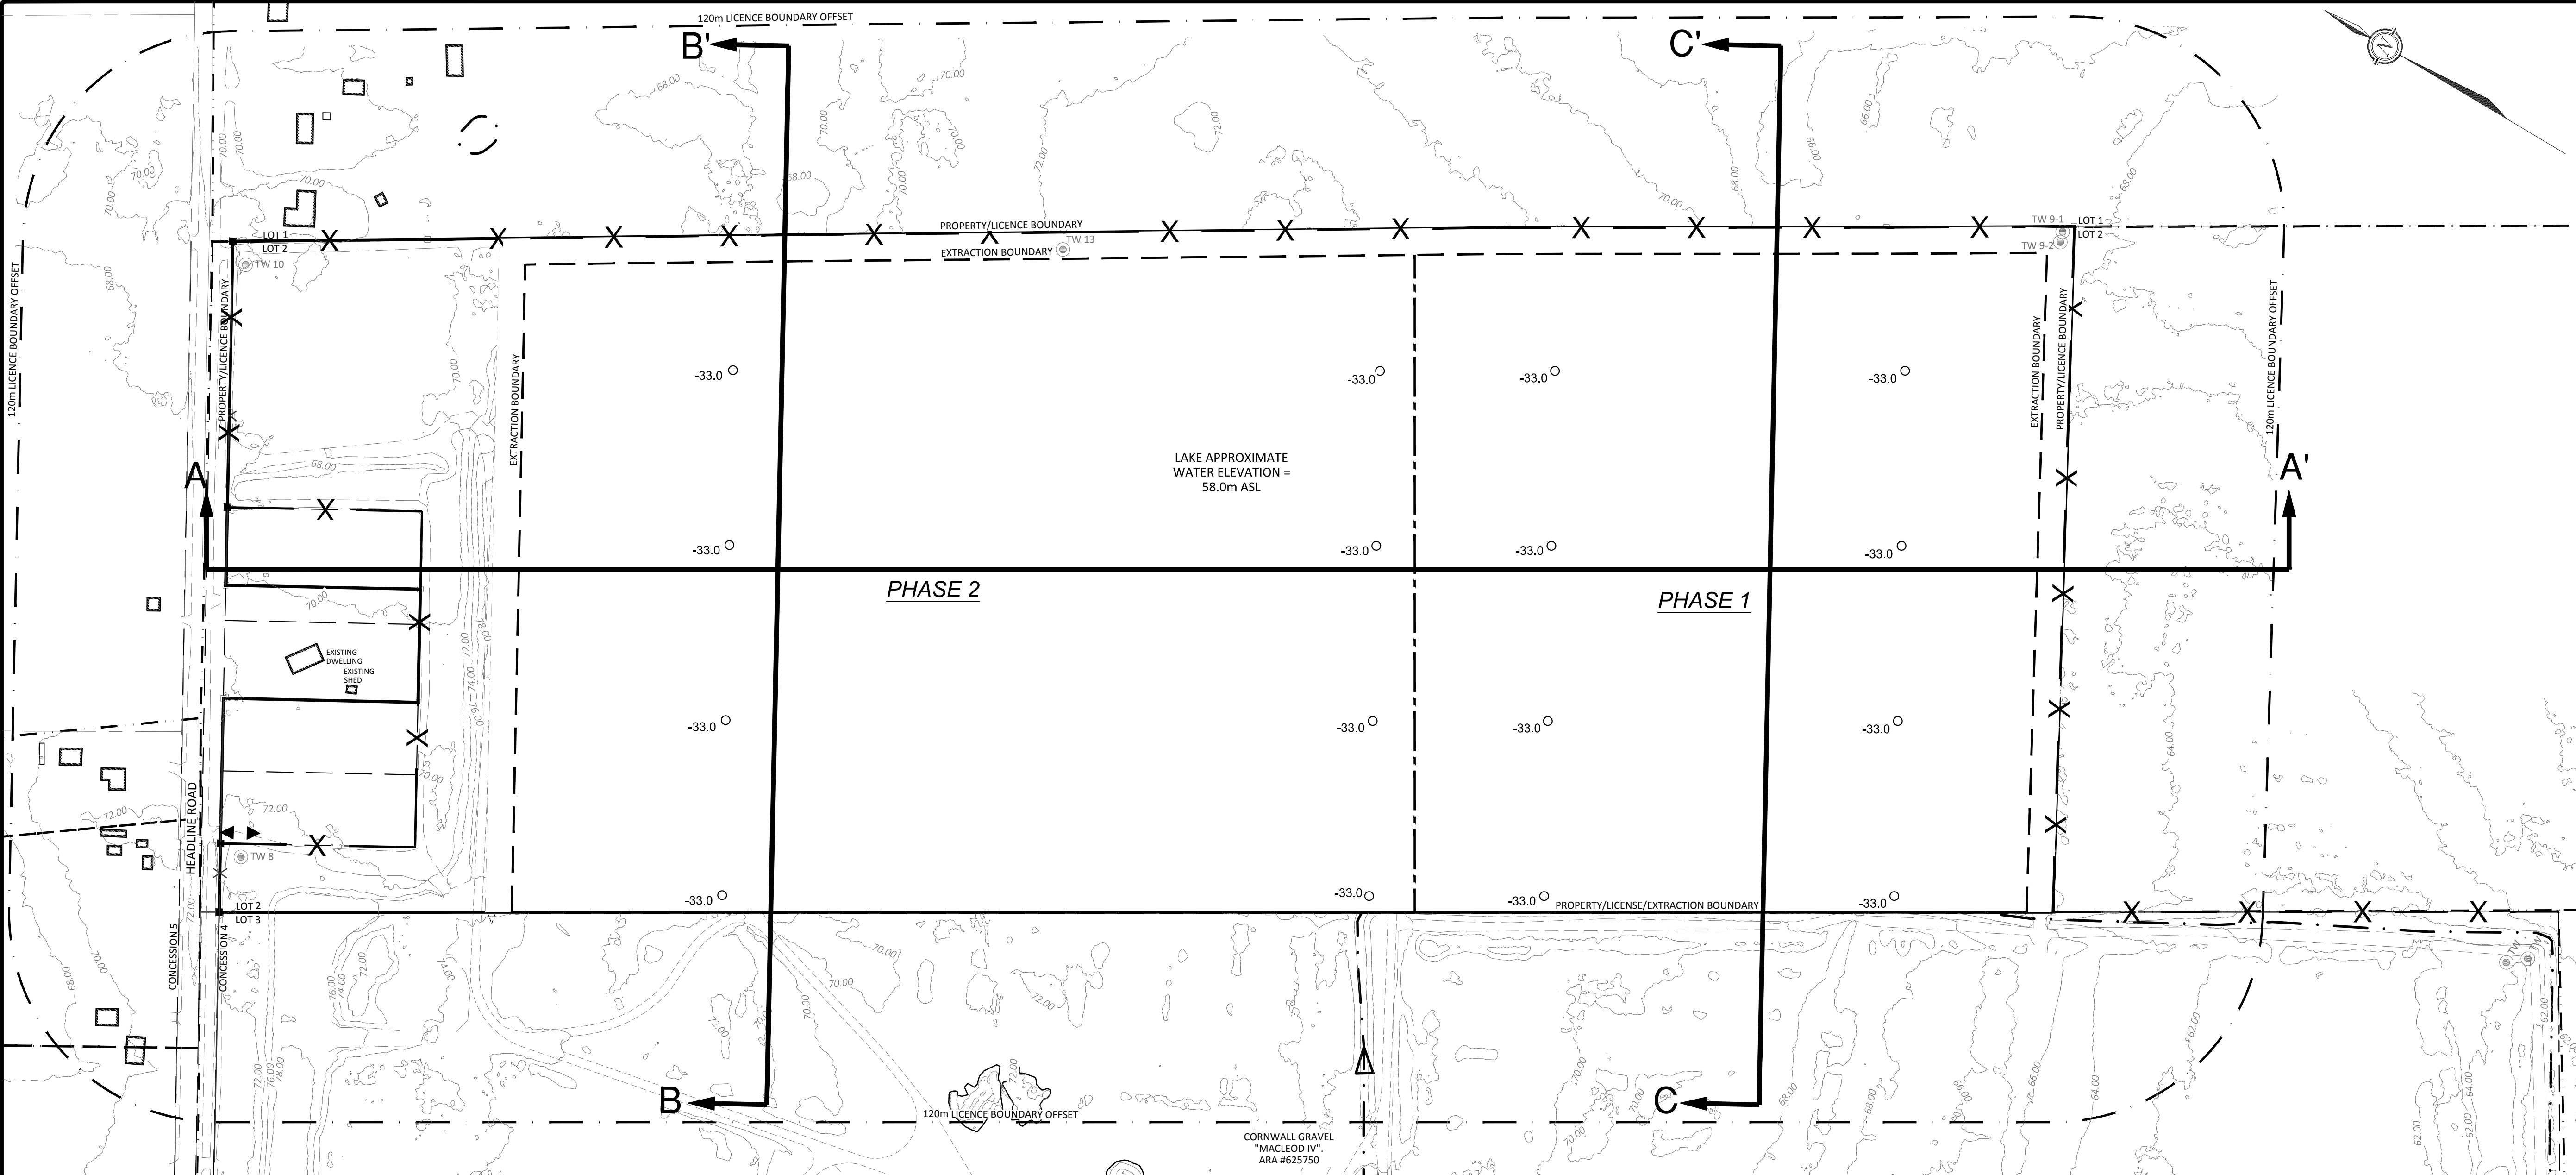LOCATION OF SITE
PART OF LOT 2
CONCESSION 4
GEOGRAPHIC TOWNSHIP OF CORNWALL
COUNTY OF SOUTH STORMONT

APPLICANT & PROPERTY OWNER
CORNWALL GRAVEL COMPANY
P.O. BOX 67 - 390 ELEVENTH STREET WEST
CORNWALL, ONTARIO, K6H 5R9

DATE _____ PETER GRANT, VICE PRESIDENT
I HAVE THE AUTHORITY
TO BIND THE CORPORATION

PLAN CERTIFICATION
I HEREBY CERTIFY THAT THIS SITE PLAN WAS PRODUCED
UNDER MY SUPERVISION.
DATE _____ MARK PRIDDLE, P.GEO.

SCALE 1 : 2000
0 50 100 150 200 Metres
DISTANCES SHOWN ARE IN METRES AND CAN BE CONVERTED TO FEET
BY DIVIDING BY 0.3048. ALL ELEVATIONS ON THIS PLAN ARE GEODETIC.

AREAS

DESCRIPTION	AREA(ha)
PROPERTY	40.5
LICENCE AREA	40.5
EXTRACTION AREA	32.4

SITE BENCHMARKS

No.	DESCRIPTION	NORTHING	EASTING	ELEVATION
A	CONTROL 7 - SCALE HOUSE WELL	4992474.452	519456.395	74.613

No.	Amendment	Date

FOR REVIEW ONLY
NOT FOR CONSTRUCTION

115 Walgreen Road R.R. #3, Carp, ON K0A 1L0
Tel: 613-836-2184 Fax: 613-836-3742

Client: CORNWALL GRAVEL COMPANY LIMITED

Project: MACLEOD 5
CATEGORY 1 CLASS "A" PIT BELOW WATER
CATEGORY 2 CLASS "A" QUARRY BELOW WATER

Drawing Title: REHABILITATION PLAN

Drawn By: DL Project Number: CP-16-0280

Checked By: MP

Paper Size: 24" x 36" Scale: 1:2000 (metric) Drawing Number: Sheet 6 of 8

Date: AUG. 17, 2017

06

SITE REHABILITATION NOTES:

REHABILITATION PLAN WAS PREPARED IN ACCORDANCE WITH THE 'AGGREGATE RESOURCES OF ONTARIO, PROVINCIAL STANDARDS VERSION 1.0' USING THE SITE PLAN STANDARDS FOR A CATEGORY 1, BELOW GROUNDWATER EXTRACTION OF PIT OPERATIONS, AND A CATEGORY 2, BELOW GROUNDWATER EXTRACTION OF QUARRY OPERATIONS.

1.3 PROGRESSIVE REHABILITATION:

1.3.1 SEQUENCE AND DIRECTION OF PROGRESSIVE REHABILITATION
PROGRESSIVE REHABILITATION WILL CONSIST OF BACKFILLING AND SLOPING TO THE BENCH CONSTRUCTED AT ELEV. 55 M AROUND THE PERIMETER OF THE EXTRACTION AREA. THE BENCH WILL BE BACKFILLED USING NATIVE OVERBURDEN STOCKPILED WITHIN THE LICENSED AREA. PROGRESSIVE REHABILITATION OF THE FIRST LIFT WILL START DURING THE MINING OF THE SECOND LIFT AND WILL BE IN A NORTH TO SOUTH DIRECTION FOLLOWING THE PROGRESSION OF THE MINING.

1.3.2 USE OF OVERBURDEN IN PROGRESSIVE REHABILITATION
AS PART OF THE OPERATIONAL PLANS, SUFFICIENT AMOUNT OF NATIVE OVERBURDEN AND NATIVE TOPSOIL WILL HAVE BEEN STORED IN STOCKPILES/BERMS IN ORDER TO REHABILITATE THE SITE (REFER TO NOTE 1.2.2). SIDE SLOPES WILL BE CREATED USING NATIVE OVERBURDEN FROM THE SITE TO PROVIDE A MAXIMUM SLOPE OF 2(H):1(V) TO 55 M ASL. A MINIMUM OF 100MM OF NATIVE TOPSOIL SHALL COVER THE OVERBURDEN ON THE GRADED SIDE SLOPES.

1.3.3 VEGETATION TO BE ESTABLISHED DURING PROGRESSIVE REHABILITATION
DURING PROGRESSIVE REHABILITATION, SLOPES WILL BE SEEDED USING A LEGUME PASTURE FIELD MIX TO AID WITH THE IMMEDIATE VEGETATION PROCESS. SEED SHALL BE APPLIED AS RECOMMENDED BY THE SUPPLIER. AFTERWARDS THE SLOPES SHALL BE LEFT TO REGENERATE NATURALLY WITH LOCAL VEGETATION SPECIES. VEGETATED SLOPES WILL BE MONITORED TO ENSURE SLOPE EROSION IS MINIMIZED.

1.3.4 QUARRY SLOPING
DURING QUARRY EXTRACTION AGGREGATE MAY BE EXCAVATED IN VERTICAL LIFTS AS NOTED ON THE QUARRY OPERATIONS PLAN. REHABILITATION OF THE QUARRY WILL INCLUDE THE IN-FILLING OF THE VERTICAL SECTIONS WITH NATIVE MATERIAL TO ACHIEVE A MAXIMUM SLOPE OF 2(H):1(V).

1.3.5 PROGRESSIVE REHABILITATION IN RELATION TO THE OPERATION SEQUENCE
THE PERIMETER OF THE EXTRACTION AREA WILL BE PROGRESSIVELY REHABILITATED ONCE THE AREA HAS BEEN DEPLETED OF MARKETABLE AGGREGATE MATERIALS AND ENOUGH AREA IS AVAILABLE TO ENSURE THAT REHABILITATION ACTIVITIES WILL NOT INTERFERE WITH THE OPERATION.

1.3.6 AND 1.4.1 PROPOSED IMPORTATION OF MATERIAL TO FACILITATE REHABILITATION
NO IMPORTATION OF TOPSOIL FOR REHABILITATION PURPOSES IS ANTICIPATED.

1.4 FINAL REHABILITATION NOTES:

1.4.2 HOW THE FINAL SLOPES WILL BE ESTABLISHED ON ALL EXCAVATION FACES AND THE QUARRY FLOOR
FINAL QUARRY SLOPES WILL BE A MAXIMUM OF 2(H):1(H) ALONG THE ENTIRE NORTHERN, EASTERN AND SOUTHERN, BOUNDARY OF THE SITE. NO REHABILITATION WILL OCCUR ON THE WESTERN BOUNDARY OF THE SITE WHERE THERE IS A COMMON BOUNDARY WITH THE ADJACENT MACLEOD IV QUARRY. SLOPES WILL BE AT 2(H):1(V) TO A MINIMUM OF APPROXIMATELY 3 M BELOW ANTICIPATED LAKE LEVEL. THE FINAL QUARRY FLOOR ELEVATION SHALL BE -33.0M ASL.

1.4.3 VEGETATION TO BE ESTABLISHED DURING FINAL REHABILITATION
MUCH OF THE VEGETATION ON THE SLOPES WILL BE ESTABLISHED DURING PROGRESSIVE REHABILITATION AS DESCRIBED IN NOTE 1.3.3. UPON FINAL REHABILITATION, SLOPED AREAS SHALL BE INSPECTED ANNUALLY TO ENSURE THAT A 60% OR HIGHER SURVIVAL RATE OF THE PLANTINGS IS ACHIEVED FOR 5 YEARS POST REHABILITATION. IF OBJECTIVES ARE NOT ACHIEVED, THEN PLANTINGS SHALL BE SUPPLEMENTED TO ACHIEVE THE 60% SURVIVAL RATE.

1.4.4 BUILDINGS/STRUCTURES TO REMAIN ONSITE
UPON FINAL REHABILITATION THE USE OF ANY BUILDINGS ON SITE SHALL BE DETERMINED BY THE OWNER.

1.4.5 ANTICIPATED ELEVATION FINAL LAKE LEVEL
THE ANTICIPATED FINAL ELEVATION OF THE GROUNDWATER TABLE ON SITE IS +58M ASL AS SHOWN ON THE CROSS-SECTIONS.

1.4.6 INTERNAL HAUL ROADS TO REMAIN
NO INTERNAL HAUL ROADS WILL REMAIN ON SITE AFTER EXTRACTION IS COMPLETED. ACCESS ROADS MAY REMAIN AT THE DISCRETION OF THE OWNER.


1.4.7 FINAL SURFACE WATER DRAINAGE
AT THE COMPLETION OF EXTRACTION THE SITE WILL BE A LAKE WITH AN ANTICIPATED FINAL WATER ELEVATION OF +58M ASL. THERE WILL BE A MINOR IMPACT ON THE OVERALL SURFACE WATER DRAINAGE AROUND THE SITE. SURFACE FLOWS TO THE NORTH AND WEST PORTION OF THE SITE WILL BE REDUCED SLIGHTLY WITH WATER REMAINING ON SITE CONTAINED IN THE LAKE.

1.4.8 FINAL ELEVATIONS OF THE REHABILITATED SITE
THE FINAL ELEVATIONS OF THE REHABILITATED SITE IS ILLUSTRATED ON THE PLAN BY A 1M CONTOUR INTERVAL EXPRESSED AS METRES ABOVE SEA LEVEL (ASL).


1.4.9 LOCATION OF CROSS-SECTIONS OF REHABILITATED PLAN
THE LOCATION OF THE THREE (3) CROSS-SECTIONS ARE SHOWN ON THE PLAN.

LEGEND	
	EXISTING GROUND SURFACE CONTOUR (m asl)
	EXISTING BUILDING
	PROPERTY LINE
	LICENCE BOUNDARY
	EXTRACTION BOUNDARY
	120m LICENCE OFFSET
	MUNICIPAL ROAD (ASPHALT)
	EXISTING DITCH LINE
	REHABILITATED SITE CONTOURS
	ANTICIPATED QUARRY FLOOR ELEVATION (m asl)
	PHASE LIMITS
	EXISTING OFFSITE LEGAL
	EXISTING FENCE LINE
	1.2m HIGH POST AND WIRE FENCE


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NO.	VARIATIONS FROM OPERATIONAL STANDARDS	APPROVED BY INSPECTOR	DATE
	NO EXCAVATION SETBACK ALONG THE WEST BOUNDARY THAT ABUTS WITH CORNWALL GRAVEL PROPERTIES		
	A COMMON BOUNDARY AGREEMENT DOWN TO ELEV. -33.0m BETWEEN MACLEOD IV AND MACLEOD V ALONG WEST BOUNDARY		
	NO FENCING ALONG THE WEST BOUNDARY THAT ABUTS WITH CORNWALL GRAVEL PROPERTIES		
	EXCESS TOPSOIL MAY BE REMOVED FROM THE SITE		
	EXCESS OVERBURDEN MAY BE REMOVED FROM THE SITE		

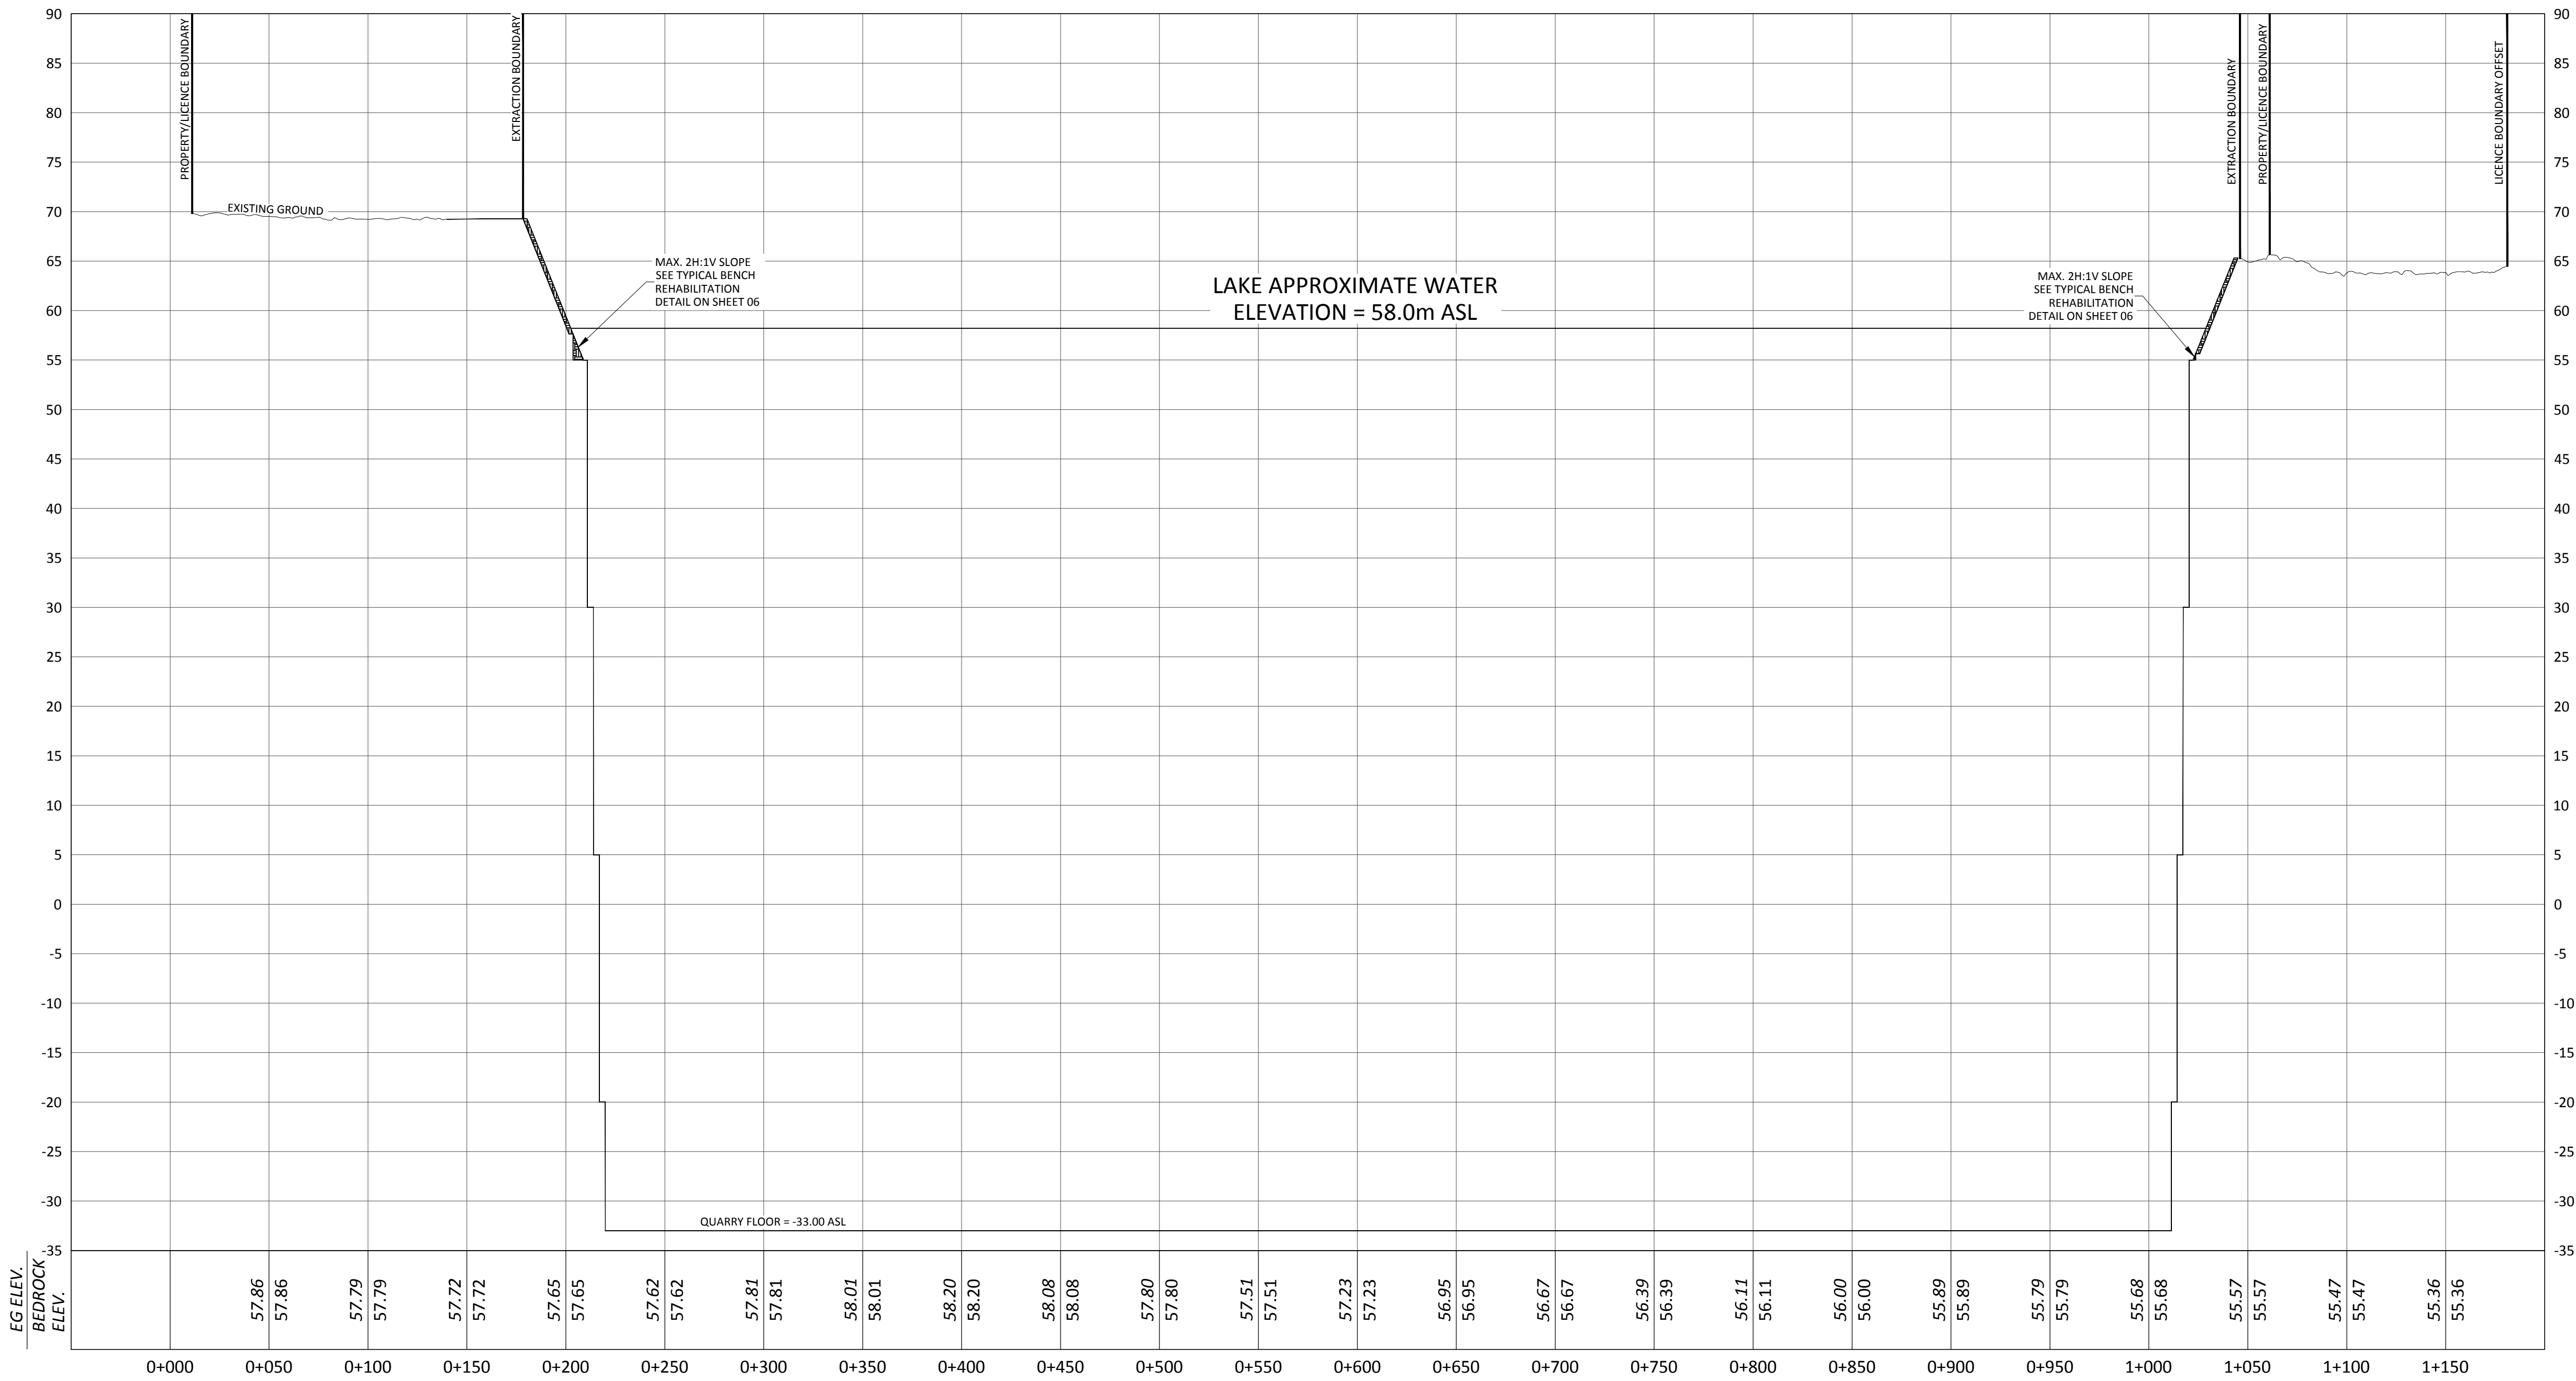

ARA No. _____

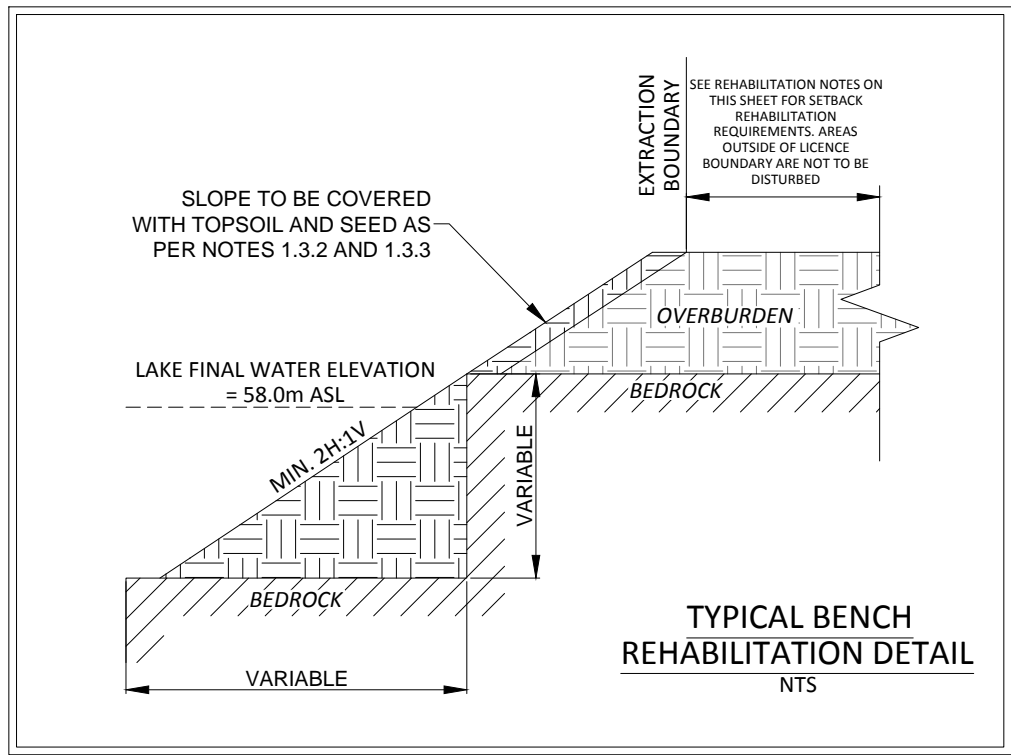

LOCATION OF SITE
PART OF LOT 2
CONCESSION 4
GEOGRAPHIC TOWNSHIP OF CORNWALL
COUNTY OF SOUTH STORMONT

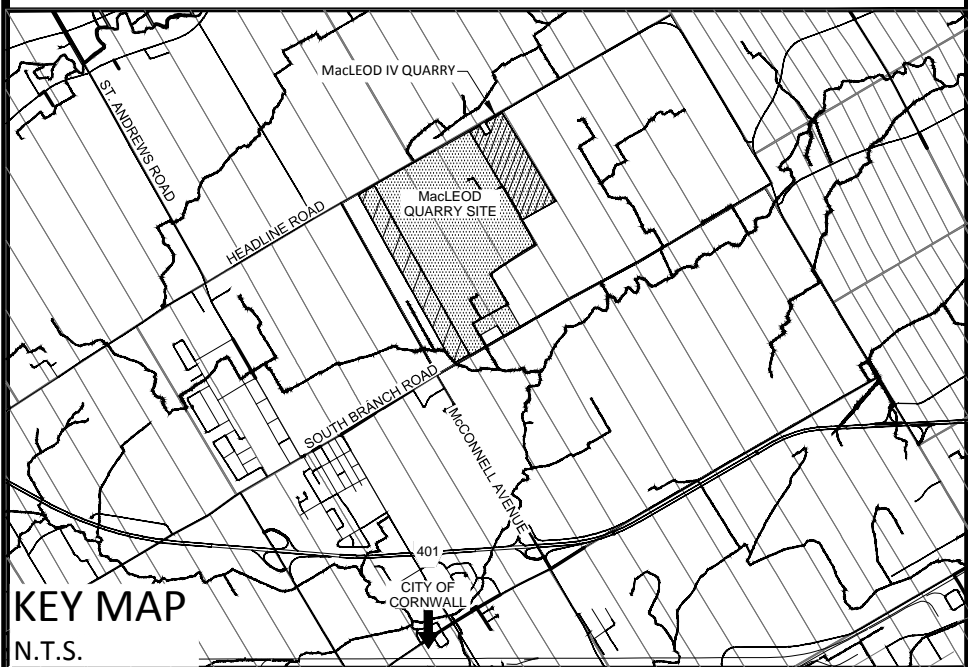APPLICANT & PROPERTY OWNER
CORNWALL GRAVEL COMPANY
P.O. BOX 67 - 390 ELEVENTH STREET WEST
CORNWALL, ONTARIO, K6H 5R9

DATE _____ PETER GRANT, VICE PRESIDENT
I HAVE THE AUTHORITY
TO BIND THE CORPORATION

PLAN CERTIFICATION
I HEREBY CERTIFY THAT THIS SITE PLAN WAS PRODUCED
UNDER MY SUPERVISION.

DATE _____ MARK PRIDDLE, P.GEO.

SCALE 1 : 2000
0 50 100 150 200 Metres
DISTANCES SHOWN ARE IN METRES AND CAN BE CONVERTED TO FEET
BY DIVIDING BY 0.3048. ALL ELEVATIONS ON THIS PLAN ARE GEODETIC.

AREAS	DESCRIPTION	AREA(ha)
	PROPERTY	40.5
	LICENCE AREA	40.5
	EXTRACTION AREA	32.4

SITE BENCHMARKS	No.	DESCRIPTION	NORTHING	EASTING	ELEVATION
	A	CONTROL 7 - SCALE HOUSE WELL	4992474.452	519456.395	74.613

No.	Amendment	Date

FOR REVIEW ONLY
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McINTOSH PERRY **MP**
115 Walgreen Road R.R. #3, Carp, ON K0A 1L0
Tel: 613-836-2184 Fax: 613-836-3742



Client:
CORNWALL GRAVEL COMPANY LIMITED

Project:
MACLEOD 5
CATEGORY 1 CLASS "A" PIT BELOW WATER
CATEGORY 2 CLASS "A" QUARRY BELOW WATER

Drawing Title:
REHABILITATION SECTIONS (1)


Drawn By: DL	Project Number:
Checked By: MP	CP-16-0280
Paper Size: 24" x 36"	Drawing Number:
Scale: 1:2000 (metric)	Sheet 7 of 8
Date: AUG. 17, 2017	

FILENAME: A:\2016\Projects\2016\06\06 Cornwall Gravel - 2016 Application - Cornwall 5 - Rehabilitation.dwg
LAST SAVED: Thursday, August 17, 2017 1:57:58 PM
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NO.	VARIATIONS FROM OPERATIONAL STANDARDS	APPROVED BY INSPECTOR	DATE
	NO EXCAVATION SETBACK ALONG THE WEST BOUNDARY THAT ABUTS WITH CORNWALL GRAVEL PROPERTIES		
	A COMMON BOUNDARY AGREEMENT DOWN TO ELEV. -33.0m BETWEEN MACLEOD IV AND MACLEOD V ALONG WEST BOUNDARY		
	NO FENCING ALONG THE WEST BOUNDARY THAT ABUTS WITH CORNWALL GRAVEL PROPERTIES		
	EXCESS TOPSOIL MAY BE REMOVED FROM THE SITE		
	EXCESS OVERBURDEN MAY BE REMOVED FROM THE SITE		

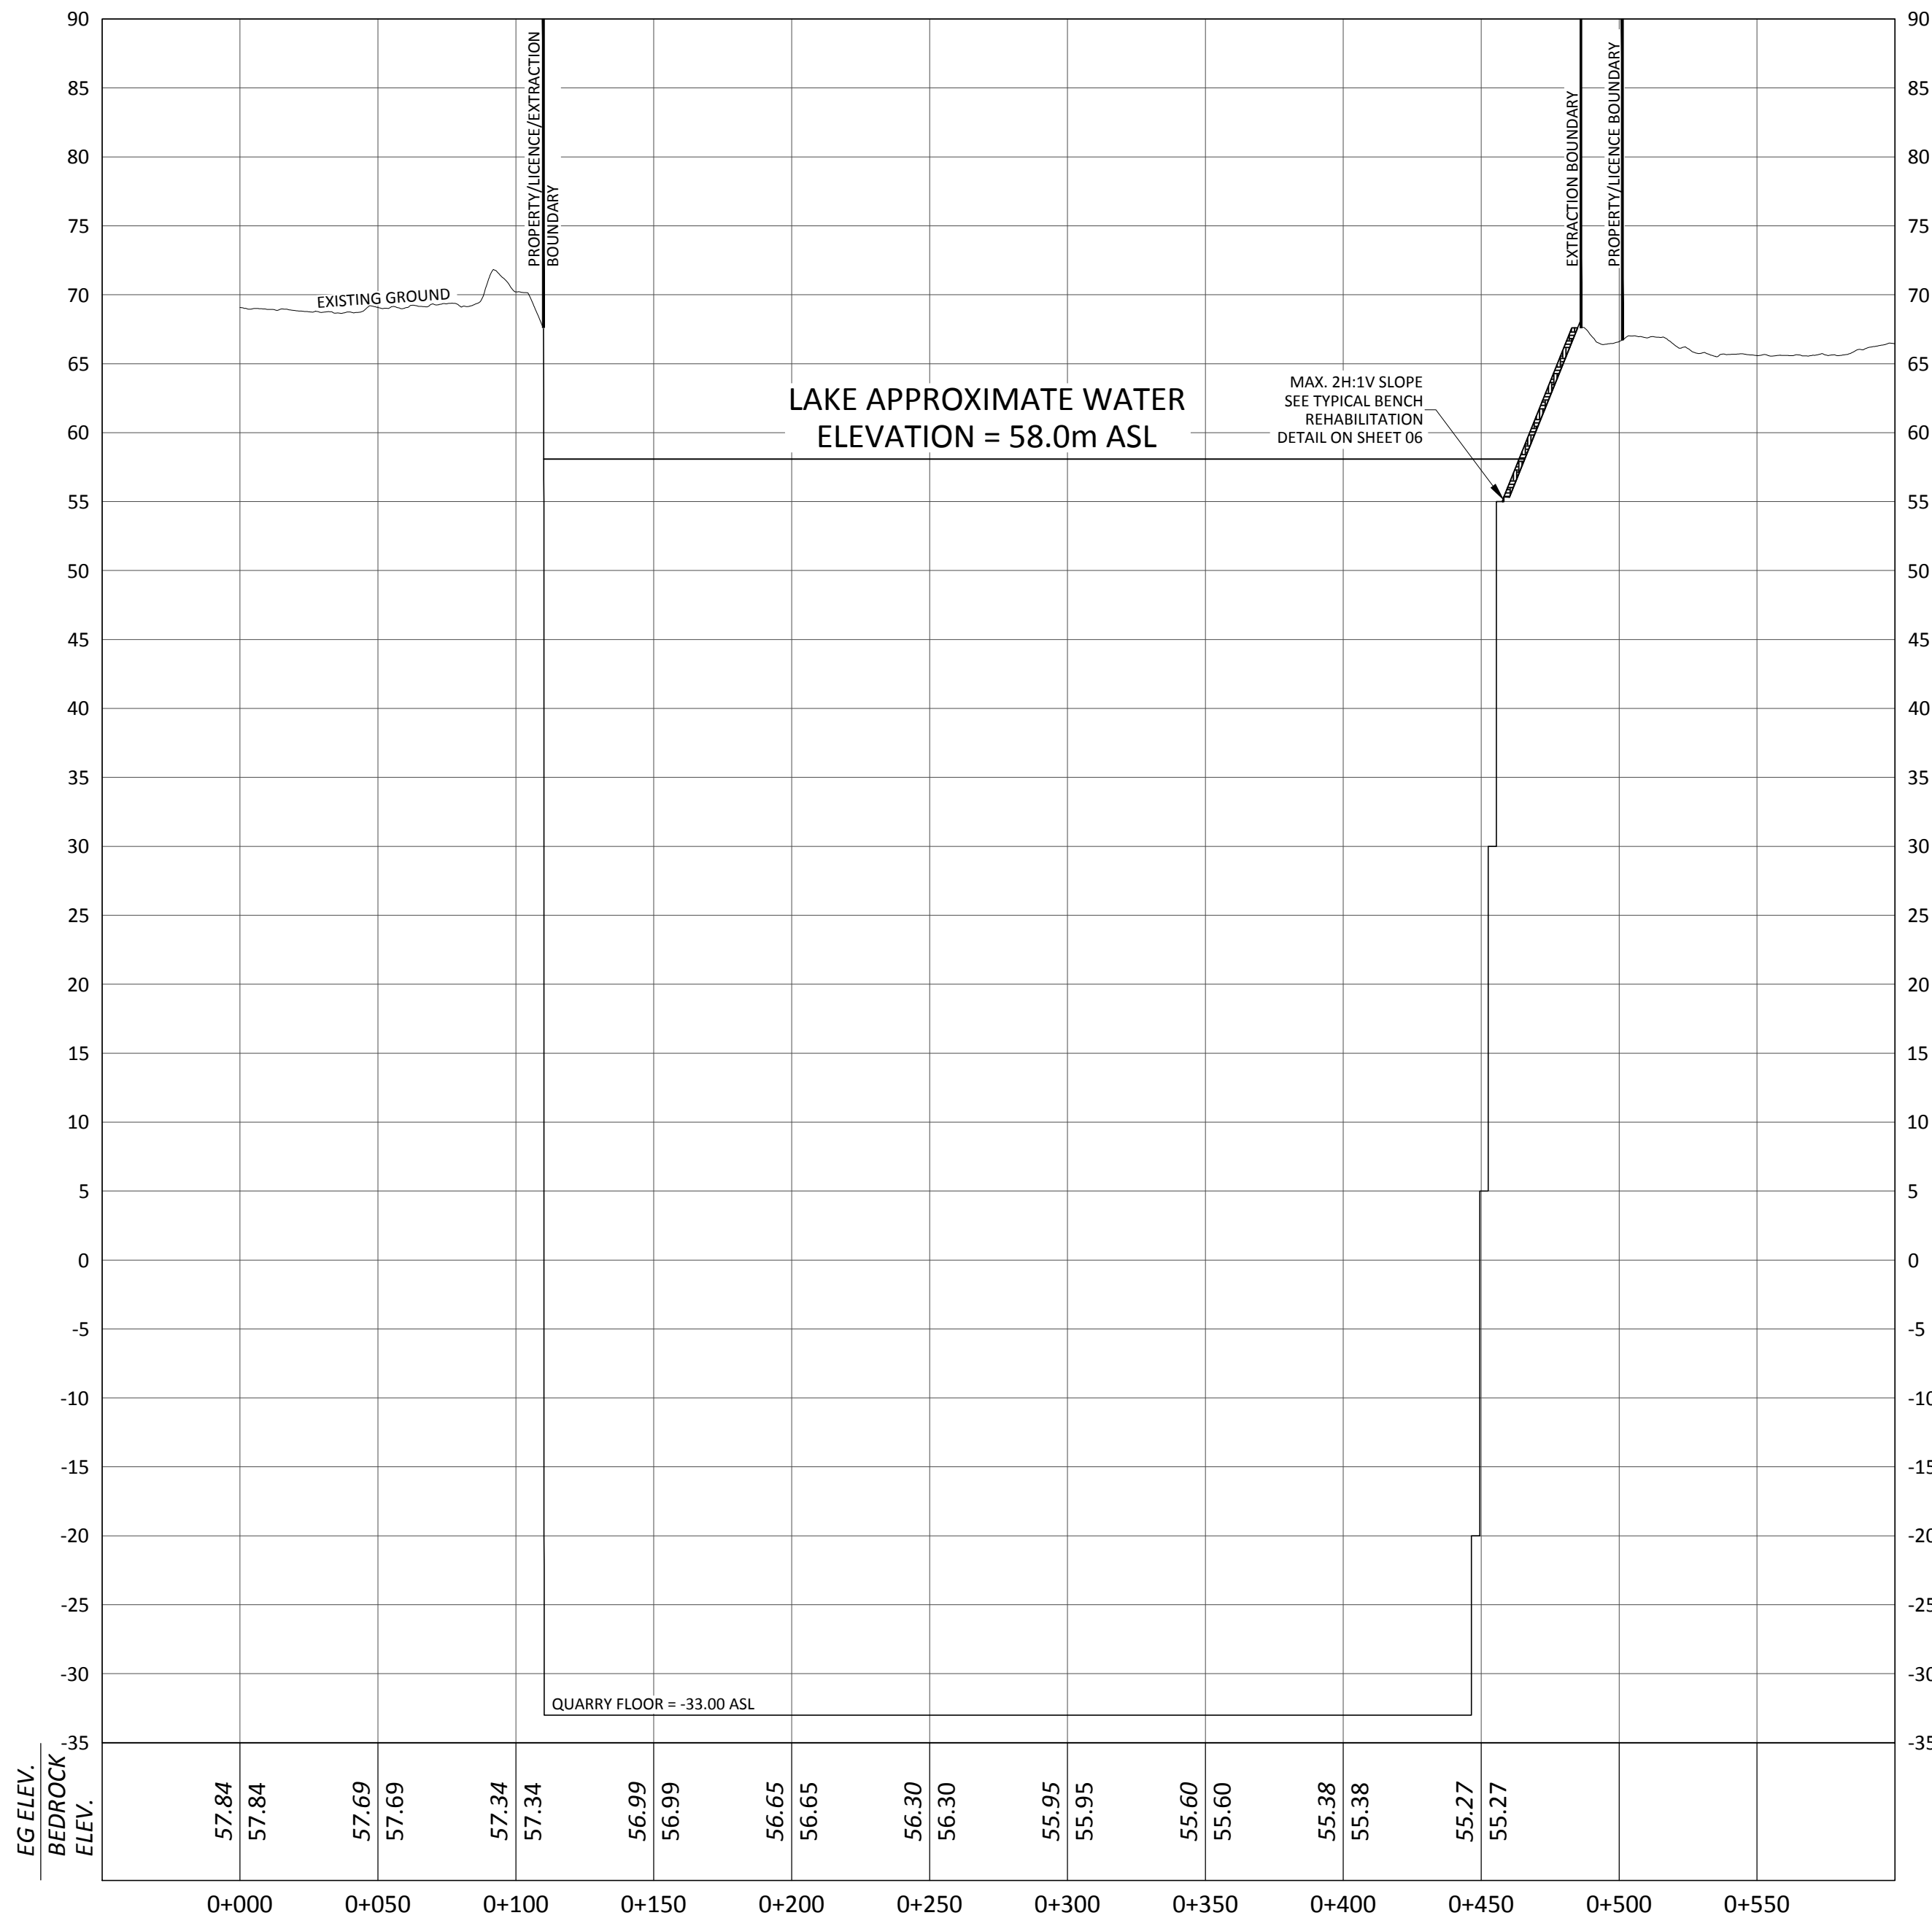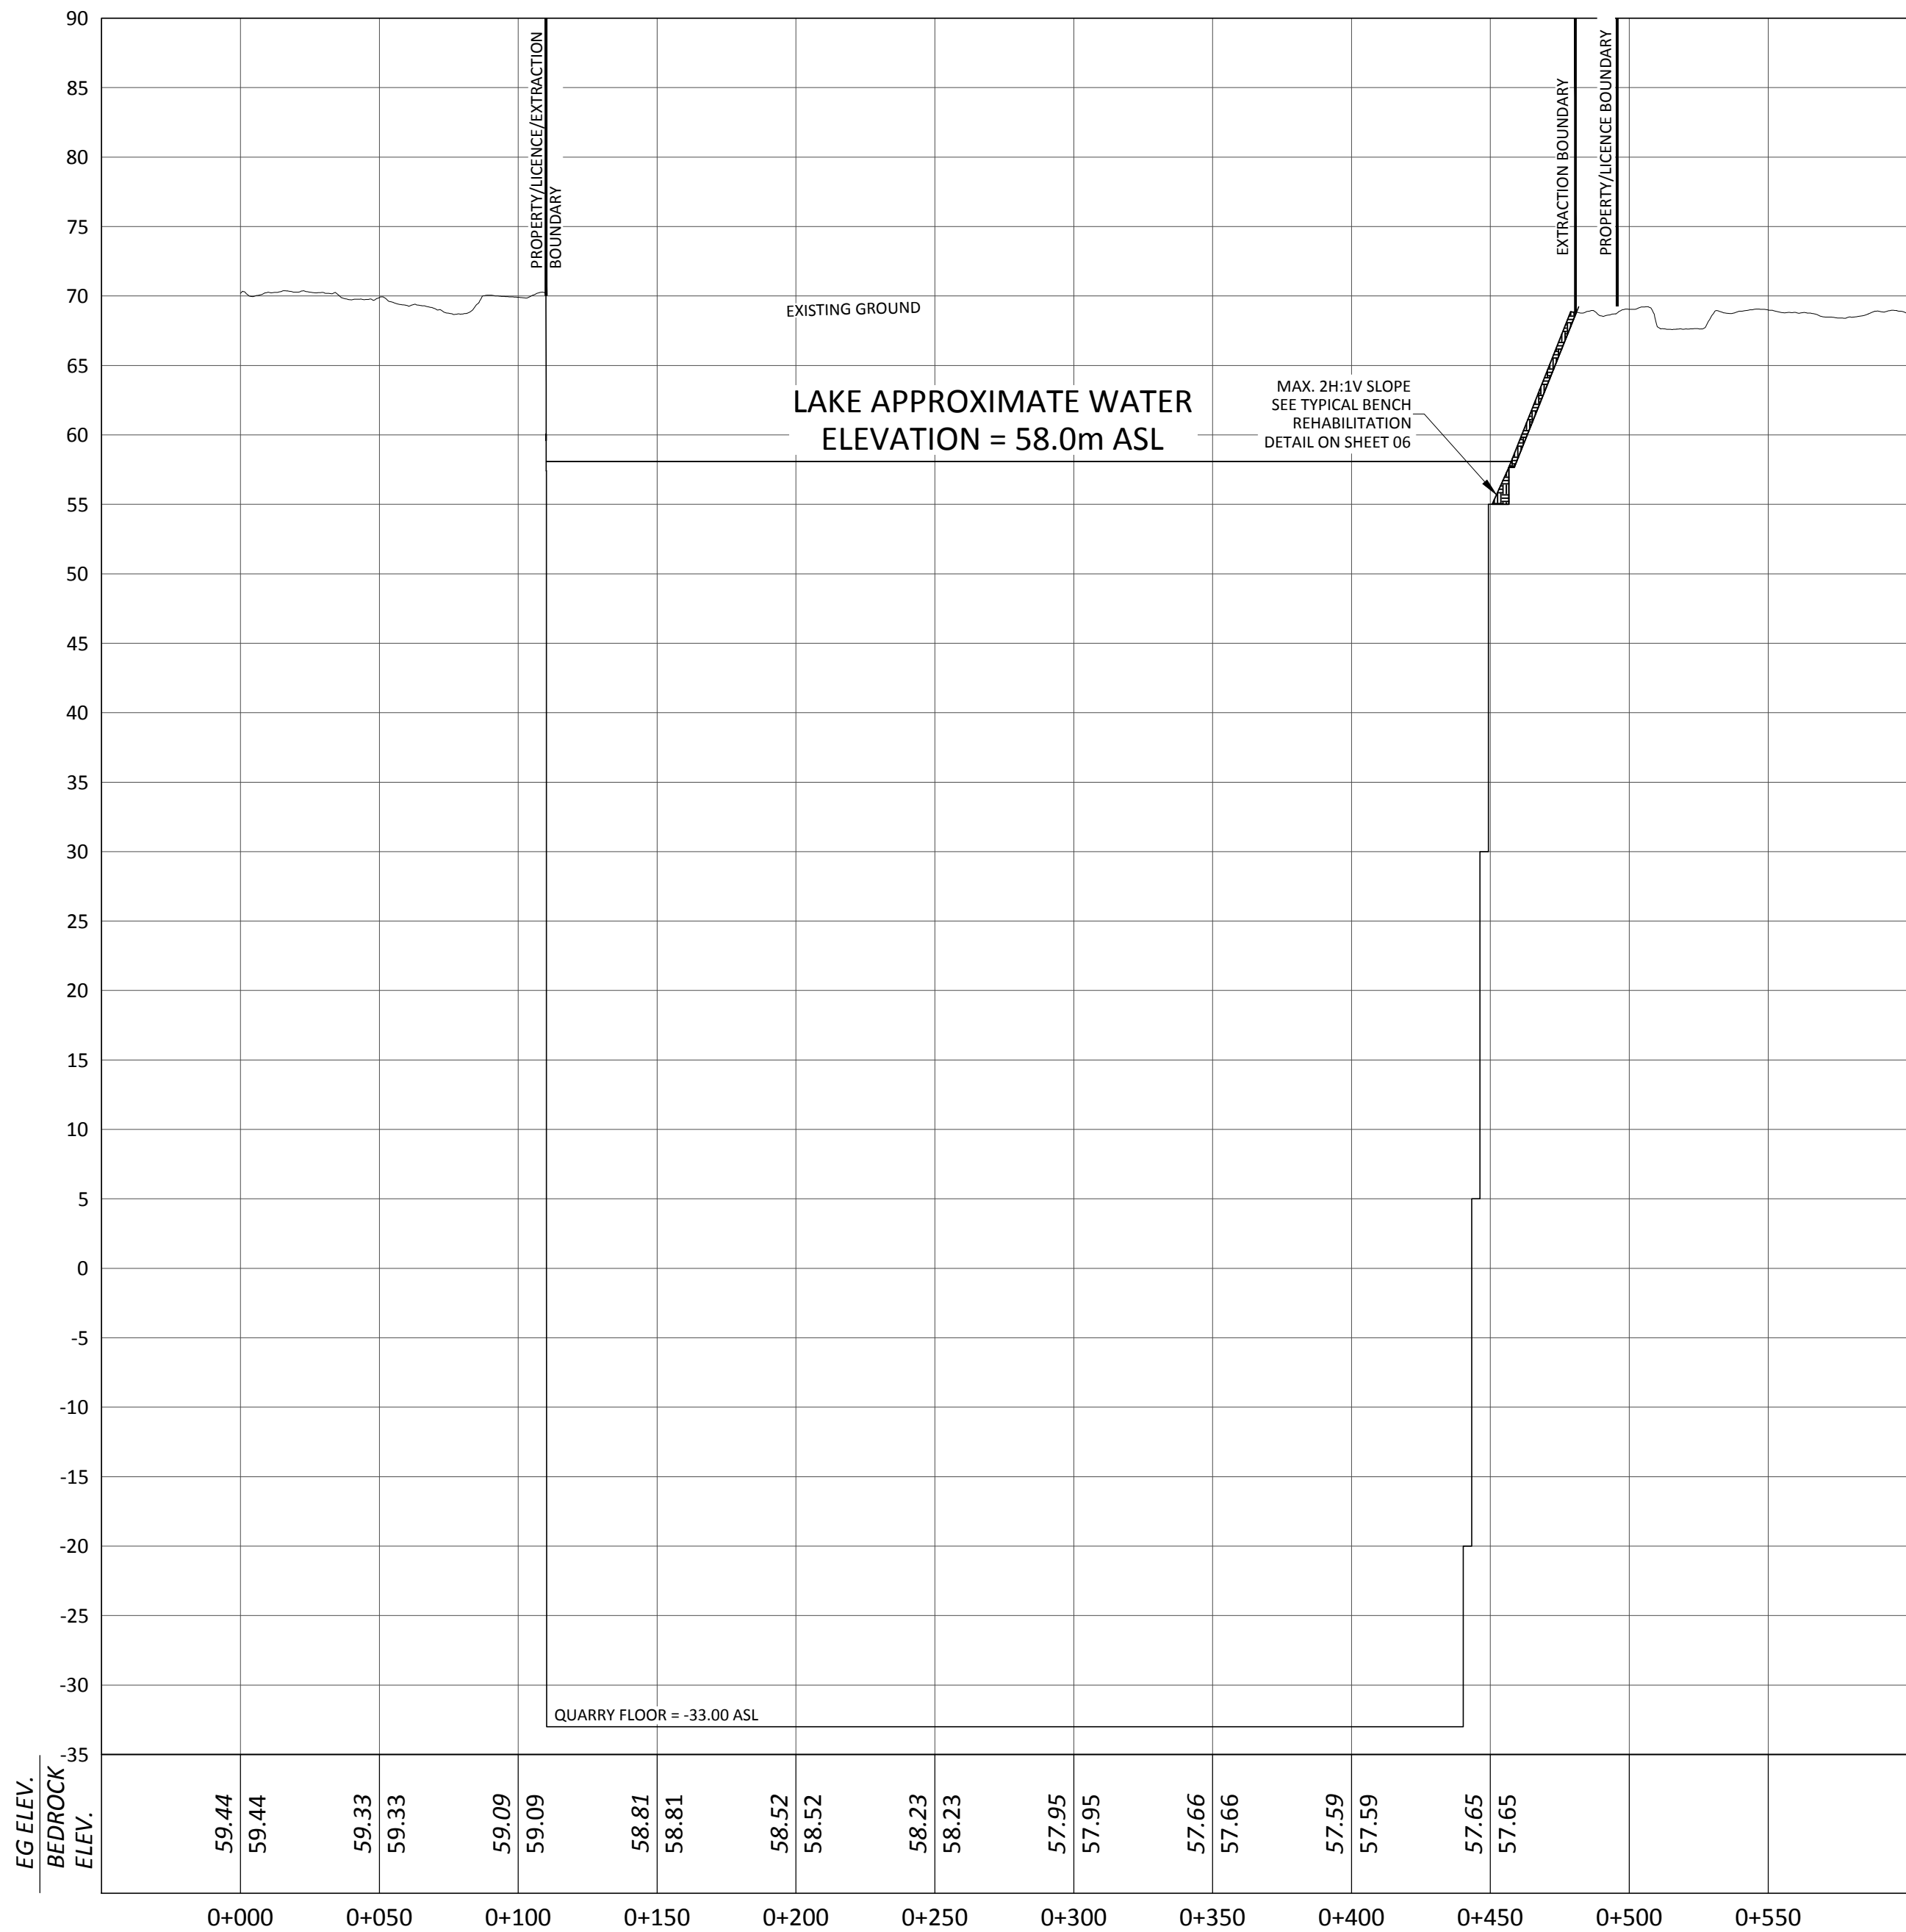ARA No. _____



KEY MAP
N.T.S.

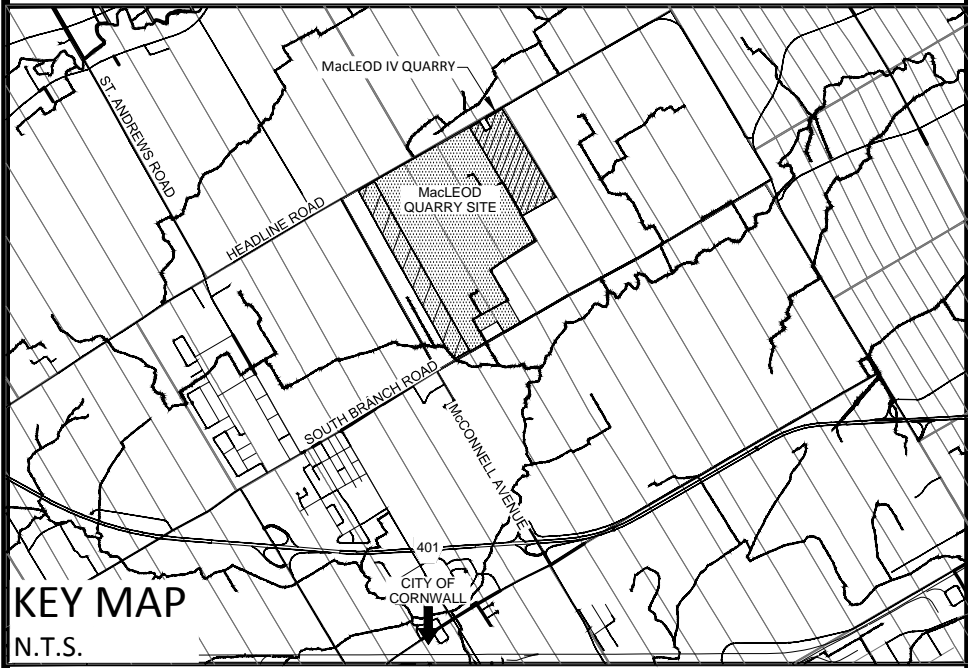LOCATION OF SITE
PART OF LOT 2
CONCESSION 4
GEOGRAPHIC TOWNSHIP OF CORNWALL
COUNTY OF SOUTH STORMONT

APPLICANT & PROPERTY OWNER
CORNWALL GRAVEL COMPANY
P.O. BOX 67 - 390 ELEVENTH STREET WEST
CORNWALL, ONTARIO, K6H 5R9

DATE _____ PETER GRANT, VICE PRESIDENT
I HAVE THE AUTHORITY
TO BIND THE CORPORATION

PLAN CERTIFICATION
I HEREBY CERTIFY THAT THIS SITE PLAN WAS PRODUCED
UNDER MY SUPERVISION.

DATE _____ MARK PRIDDLE, P.GEO.

SCALE 1 : 2000
0 50 100 150 200 Metres
DISTANCES SHOWN ARE IN METRES AND CAN BE CONVERTED TO FEET
BY DIVIDING BY 0.3048. ALL ELEVATIONS ON THIS PLAN ARE GEODETIC.

AREAS

DESCRIPTION	AREA(ha)
PROPERTY	40.5
LICENCE AREA	40.5
EXTRACTION AREA	32.4

SITE BENCHMARKS				
No.	DESCRIPTION	NORTHING	EASTING	ELEVATION
A	CONTROL 7 - SCALE HOUSE WELL	4992474.452	519456.395	74.613

No.	Amendment	Date

McINTOSH PERRY **MP**
115 Walgreen Road R.R. #3, Carp, ON K0A 1I0
Tel: 613-836-2184 Fax: 613-836-3742

Client:
CORNWALL GRAVEL COMPANY LIMITED

Project:
MACLEOD 5
CATEGORY 1 CLASS "A" PIT BELOW WATER
CATEGORY 2 CLASS "A" QUARRY BELOW WATER

Drawing Title:
REHABILITATION SECTIONS (2)

Drawn By: DL	Project Number:
Checked By: MP	CP-16-0280
Paper Size: 24" x 36"	Drawing Number:
Scale: 1:2000 (metric)	Sheet 8 of 8
Date: AUG. 17, 2017	